

Architecture | Engineering

ADDENDUM 01

Addendum #	01 Date Is	sued 03/21/2025
Project Name Job #	SWN 0509, Waneta Hall Renovate Restrooms	OSE # R032515X EAPC #20256780
Bid Date Time	April 3, 2025	3:30pm

THIS ADDENDUM AMENDS AND BECOMES PART OF THE CONTRACT DOCUMENTS FOR EAPC PROJECT 20246780 DATED 03/13/2025, RESPECTIVELY. EACH BIDDER SHALL ACKNOWLEDGE RECEIPT OF THIS ADDENDUM BY MARKING THE ADDENDUM NUMBER AND DATE ON THE BID FORM.

SPECIFICATIONS

Bid Form ADD Total value of material subject to tax: \$150,920

DRAWINGS

A101 REVISE extents of concrete demolition.

REVISE Keynote AD 10.

A200 ADD Keynote AE 35.

A201 REVISE extents of concrete pad.

REVISE Keynotes AE 35 & AE 52.

A301 REVISE Issue Date.

REVISE General Ceiling Note #6. ADD Keynotes AE 02 and AE 03.

Revise ceiling and lighting layouts in rooms 125, 175 and the hallways around

the new construction.

A302 REVISE General Ceiling Note #6.

ADD Keynote AE 03.

Revise lighting layouts in the hallways around the new construction.

ADD notes for extents of Alt. #5 on 1/A302.

A303 REVISE General Ceiling Note #6.

ADD Keynote AE 03.

Revise lighting layouts in the hallways around the new construction.

A304 REVISE issue date.

REVISE lighting layout on at the student space 102. Extend wall in Kitchen 130

to ceiling.

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ADDENDUM 01 continued

P200	REVISE plumbing pipe routing to stay within tunnel space regarding Alternate 02 work.
P201	REVISE plumbing pipe routing in wall associated with Alternate 02.
M201	REVISE ERU's and associated ACCU's locations for concrete pad and clearances.
M301	REVISE ERU and ACCU locations for concrete pad and clearances. ADD section view for ductwork installation.
E101	CLARIFIATION on existing panel names.
E102	CLARIFIATION on panel names.
E103	CLARIFIATION on panel names and demo at RM 326.
E200	ADD location for MDP.
E201	ADD location for mechanical equipment and duct smoke detectors. Add clarification on alternates. REVISE power at alternates ADD notes 5 and 6.
E202	ADD clarification on alternates. Add notes 3 and 4. REVISE power at Study rooms
E203	ADD note 4 for data rough in. Update power at Study rooms
E301	ADD clarification on lighting types and occupancy sensors.
E302	ADD clarification on lighting types and occupancy sensors.
E303	ADD clarification on lighting types and occupancy sensors.
E304	CLARIFIATION on alternates.
E801	REVISIONS to motor and equipment schedules for circuiting.
E802	REVISIONS to schedules.
E901	REVISIONS to schedules.
E902	REVISIONS to schedules.



ADDENDUM 01 continued

PRIOR APPROVALS

07 5300 Elastomeric Membrane Roofing - Coverboards **USG Securock** 23 2513 **HVAC Water Treatment for Closed-Loop Systems** Jaytech Girton Adams Interstate

ATTACHMENTS

Planholder's List

A101

A200

A201

A301

A302

A303

A304

P200 P201

M201

M301

E101

E102

E103 E200

E201

E202

E203

E301

E302 E303

E304

E801

E802

E901

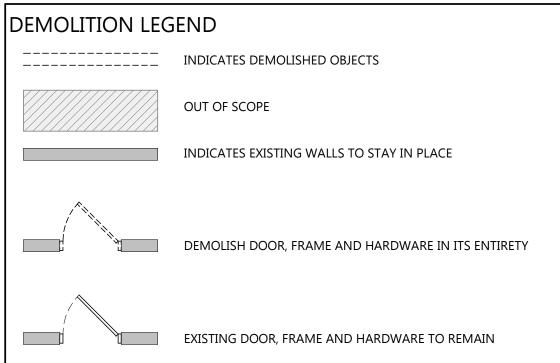
E902





PLAN HOLDERS LIST SWN 0509, Waneta Hall Renovate Restrooms OSE #R0325--15X EAPC Project: # 20246780

BID DATE: April 3, 2025
BID TIME: 3:30pm

PLAN HOLDER	CONTACT PERSON	ADDRESS	CITY	STATE	ZIP	PHONE	FAX	EMAIL
EAPC Architects Engineers	Shawn Crowley	101 N Phillips Ave Suite 300	Sioux Falls	SD	57104	604-444-1612		shawn.crowley@eapc.net
South Dakota State University	Reed Leibel	Facilities & Services Building, Box 2150	Brookings	SD	57007	605-688-5292		Reed.Leibel@sdstate.edu
Office of the State Engineer	Todd Baack	4900 S Minnesota Ave Suite 104	Sioux Falls	SD	57108	605-367-7165		todd.baack@state.sd.us
BUILDERS EXCHANGES								
Aberdeen Builders Exchange	Sherri	302 N. Jackson Street	Aberdeen	SD	57401	605-290-4210		dakotabuild@midconetwork.com
Construction Industry Center		Box 1227	Rapid City	SD	57709	605-343-5252	605-343-4591	cic@constructionindustrycenter.com or chrissy@constructionindustrycenter.com
Construct Connect	Sherri Magness					513-458-5864		Sherri.Magness@ConstructConnect.com
Disadvantaged Business Enterprise (DBE)	Kyle Watkins					605-773-4906		kyle.watkins@state.sd.us
Dodge Construction Network	Darnel Foster					844-326-3826		dodge.docs@construction.com
Fargo-Moorhead Bldrs. Exchange		P. O. Box 10076	Fargo	ND	58106	701-237-6772	701-232-1653	upload
Lincoln Builders Bureau		5910 S 58th St Ste C	Lincoln	NE	68516	402-421-8332		info@buildersbureau.com
Master Builders of Iowa		221 Park St	Des Moines	IA	50309	515-288-8904		content@isqft.com
Minnesota Builders Exchange		1123 Glenwood Avenue	Minneapolis	MN	55405	612-381-2620	612-381-2621	new project: jb@mbex.org addendums: addenda@mbex.org
Omaha Builders Exchange		4159 S 94th Street	Omaha	NE	68127	402-991-6906		lisa.shockey@omahaplanroom.com
Plains Builders Exchange		220 N. Kiwanis Ave.	Sioux Falls	SD	57104-2530	605-334-8886	605-334-0112	info@plainsbuilders.com
SD Assoc. of Plumbing/Heating		707 E 41st St #220	Sioux Falls	SD	57105	605-271-7255		phcc@midco.net
Sioux Falls Builders Exchange		1418 "C" Avenue	Sioux Falls	SD	57104	605-357-8687	605-357-8655	info@sfbx.com
Sioux City Construction League Plan Room		3900 Stadium Drive	Sioux City	IA	51101	712-255-9730		office@scaplanroom.com
Watertown Builders Exchange								duanesfloorcovering@iw.net
CONTRACTOR								
Clark Drew Construction	Matt Chandler	302 32nd Ave. S	Brookings	SD	57006	605.692.9063		matt@clarkdrewconstruction.com
Gil Haugan Construction	Gill Haugan III	200 East 60th St. N	Sioux Falls	SD	57104			Gil3@gilhaugan.com
Great Places Construction	Jason Moberg	3401 W 41st Street	Sioux Falls	SD	57106	888-687-2345		jason.moberg@greatplaceconstruction.com
Mills Construction	Paul Sahr	1311 Main Ave. S.	Brookings	SD	57006	605.690.4545	605.697.3131	Pauls@buildwithmills.com
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DEMOLITION PLAN - FIRST FLOOR - WOMENS

1/4" = 1'-0"
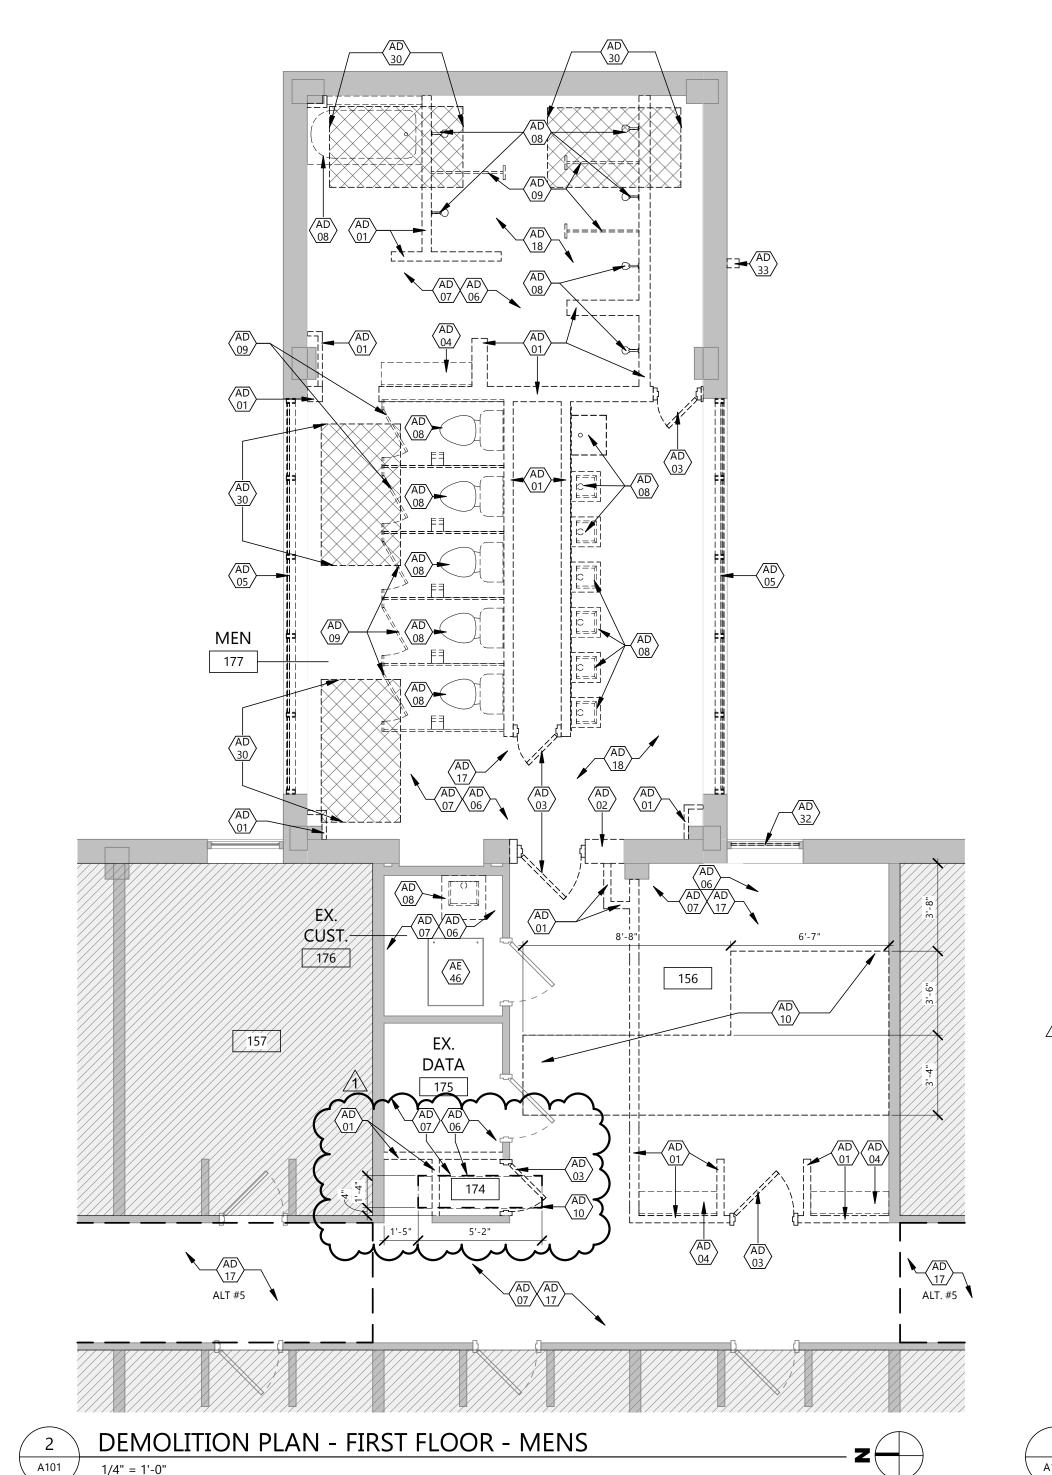
| GENERAL DEMOLITION NOTES

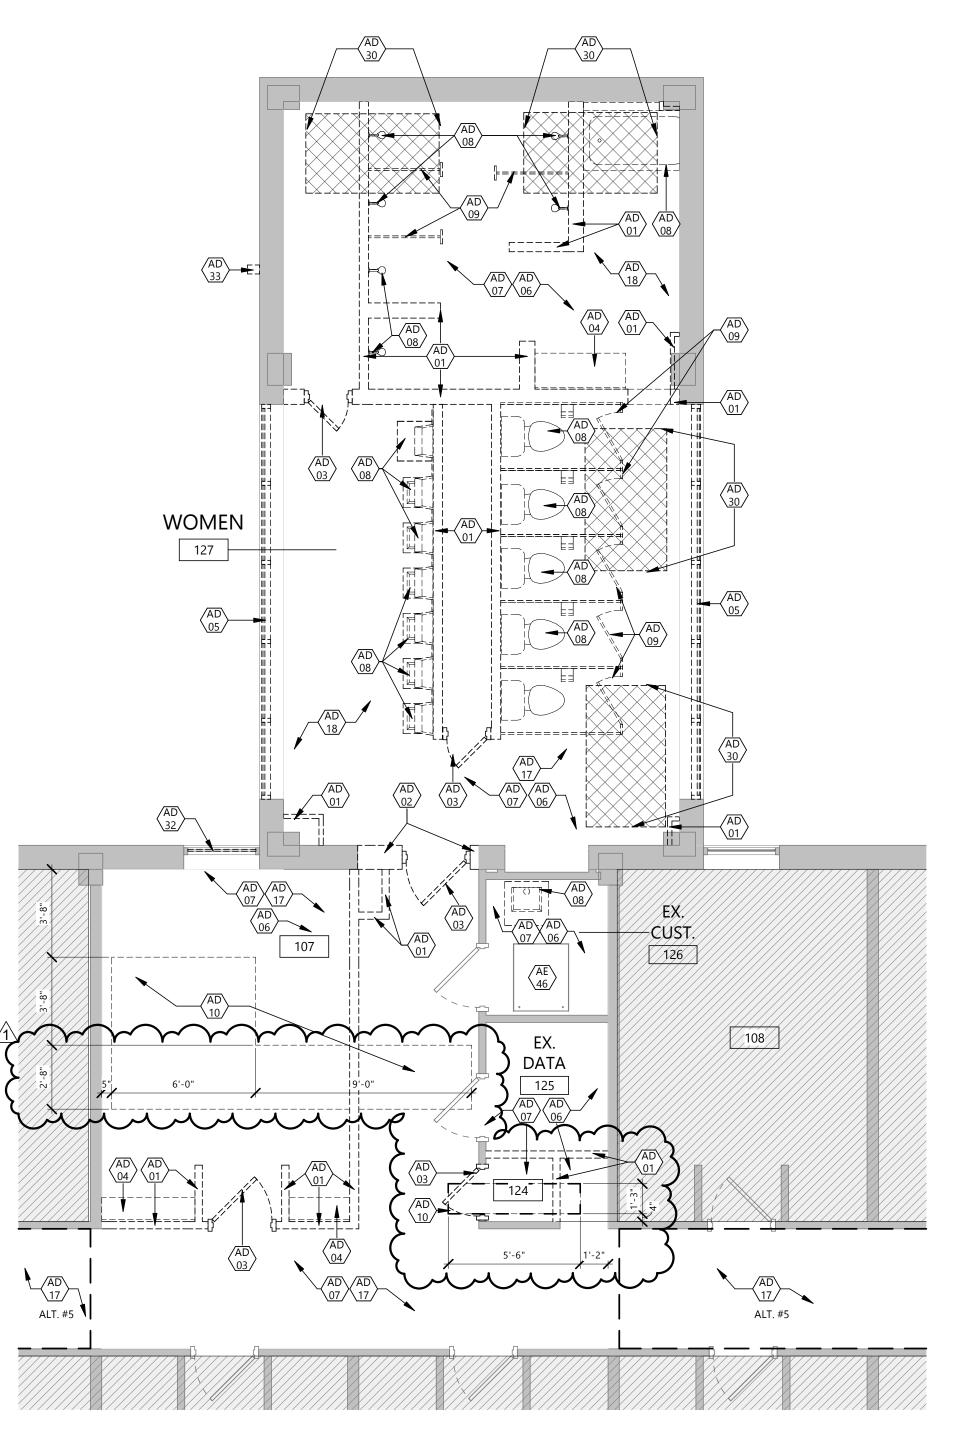EXISTING BUILDING ELEMENTS.

- 1. DASHED LINES INDICATE DEMOLITION ITEMS, SOLID LINES INDICATE EXISTING ITEMS TO REMAIN. ALSO REFER TO SHEET A001 FOR SYMBOLS AND ABBREVIATIONS.
- ALL DEMOLITION WORK AND TEMPORARY INSTALLATIONS SHALL BE ACCOMPLISHED AS SPECIFIED.
- 3. CONTRACTOR TO PROVIDE SECURE DOORS IN TEMP PARTITIONS AS NECESSARY TO MAINTAIN BUILDING SECURITY. PROVIDE CLEAR ROUTES TO EXITS FROM WORK AREA.
- FIELD VERIFY EXISTING CONDITIONS OF EACH FLOOR AND AREA TO BE DEMOLISHED.
 DEMOLITION PLANS REPRESENT APPROXIMATE LOCATION OF EXISTING WALLS TO BE DEMOLISHED. FIELD VERIFY TYPE OF CONSTRUCTION AND HEIGHT OF WALLS. PLANS DO NOT NECESSARILY INDICATE ALL DEMO WALLS, COUNTERS, HANDRAILS, WALL PROTECTION, CLOSETS, SINKS, ETC. PRIOR TO DEMOLITION FIELD VERIFY THAT WALLS TO BE REMOVED DO NOT PROVIDE SUPPORT FOR EXISTING BUILDING ELEMENTS AND EXISTING CONSTRUCTION TO REMAIN. NOTIFY A/E IF DEMOLITION WALLS SUPPORT
 - 6. REMOVE WALL COVERINGS ON EXISTING WALLS TO REMAIN THAT FACE AREAS OF DEMOLITION. REMOVAL SHALL INCLUDE ANY RESIDUAL MATERIAL AFTER DEMOLITION, I.E. PIECES OF WALL COVERING OR BACKING. REMOVAL OF WALL COVERINGS IS TO BE DONE W/O DAMAGING THE EXISTING WALL SURFACE TO REMAIN. ALSO REMOVE WALL DEVICES AND ITEMS MOUNTED TO WALLS.
 - . FIELD VERIFY EXISTING MATERIALS IN AREAS OF DEMOLITION.
- 8. REMOVE ALL MECHANICAL AND ELECTRICAL EQUIPMENT, DEVICES AND ASSOCIATED ELEMENTS AS INDICATED IN MECH AND ELEC DRAWINGS. FIELD VERIFY THE PRESENCE OF MECHANICAL AND ELECTRICAL PIPES, CONDUIT, ETC. IN ALL WALLS TO BE DEMOLISHED.
- 9. CONTRACTOR TO PROVIDE DEMOLITION IMPLEMENTATION PLANS AND SCHEDULE. NOTIFY OWNER IF ANY OPERATIONAL DISRUPTIONS OF ADJACENT OCCUPANTS ARE REQUIRED TO PERFORM NEW WORK (INCLUDING BUT NOT LIMITED TO: MECHANICAL, PLUMBING, FIRE SUPPRESSION, AND ELECTRICAL DISRUPTIONS).
- 10. CONTAIN DUST AND DEBRIS WITHIN THE DEMOLITION AREA.
- 11. DEMOLISH AND REMOVE DOORS, VINYL BASE, CONDUIT, WIRING, DUPLEXES, TELEPHONE OUTLETS, CABLES, SHELVING, METAL STUDS, AND GYPSUM BOARD WALLS, CLOSETS, CABINETS, FILES, COUNTERS, WOOD MOULDING, SHELVES AND ENCLOSURES WHERE APPLICABLE.
- 12. DEMOLISH AND REMOVE CARPET, PAD, TACK STRIP, AND RESILIENT BASE. REMOVE ALL FLOOR MATERIALS INCLUSIVE OF SETTING BEDS, SUBFLOOR MATERIAL ETC. REMOVE MASTIC TO PROVIDE A CLEAN FLOOR THAT IS ACCEPTABLE TO THE SUBCONTRACTOR INSTALLING NEW FINISH MATERIAL SPACES RECEIVING WALL DEMOLITION WILL ALSO HAVE FLOOR FINISH DEMOLITION UNO.
- 13. DEMOLISH AND REMOVE SUSPENDED ACOUSTIC LAY-IN, SPLINE, OR GYPSUM/ PLASTER CEILING INCLUSIVE OF HANGERS AND CARRYING CHANNELS, WIRES, CABLES, CONDUIT, ADHERED CEILING TILES, FLEX CONDUIT, ELECTRICAL BOXES, SMOKE DETECTORS, LIGHT FIXTURES, AND WIRING, DUCT WORK, PIPING AND SUPPORT HANGERS. CUT HANGERS FLUSH. SPACES RECEIVING WALL DEMOLITION WILL ALSO HAVE CEILING DEMOLITION LINO.
- 14. PRIOR TO COMMENCEMENT OF DEMOLITION OPERATIONS, CONTRACTOR SHALL IDENTIFY ALL UTILITIES TO REMAIN.
- 15. DEMOLITION FOR THE FLOOR AREAS SHALL ENCOMPASS THE SPACE FROM THE TOP OF THE CONCRETE FLOOR TO THE UNDERSIDE OF THE EXISTING INTERSTITIAL STRUCTURE ABOVE UNLESS NOTED OTHERWISE.
- 16. ALL DEMOLITION MATERIALS AND DEBRIS SHALL BE DISPOSED OF ACCORDING TO FEDERAL STATE AND LOCAL REGULATIONS.
- 17. CONTRACTOR SHALL PERFORM WORK IN A MANNER THAT DOES NOT DAMAGE THE EXISTING STRUCTURE. DEMOLITION SHALL NOT COMPROMISE THE STRUCTURAL
- INTEGRITY OF ANY WALLS, FLOORS, CEILING, SUPPORTS, STRUCTURE, ETC. TO REMAIN.

 18. AT LOCATIONS WHERE EXISTING WALLS ARE TO BE REMOVED NEAR EXISTING WALLS TO REMAIN, PERFORM DEMOLITION WITHOUT DISTURBING EXISTING ELEMENTS TO REMAIN. WALLS TO REMAIN SHALL BE INTACT AND HAVE A NEAT, FINISHED SURFACE WHERE
- 19. CONTRACTOR TO PROVIDE TEMPORARY GUARDS AND PROTECTION AROUND EXPOSED FLOOR AND ROOF OPENINGS AND SHAFTS PER CODE.
- 20. TYPICAL DOOR REMOVAL INCLUDES HARDWARE AND FRAME UNO.
- 21. G.C. TO REMOVE CONCRETE SLAB AS REQUIRED FOR UNDERFLOOR WORK. COORDINATE EXTENTS OF REMOVAL WITH M.C. AND E.C. TRENCHING AND BACKFILLING FOR UNDERFLOOR ITEMS SHALL TO BE PERFORMED BY M.C. OR E.C. G.C. TO INSTALL NEW FLOOR SLAB AFTER SUBBASE IS RESTORED AND ACCEPTABLE TO G.C.
- 22. THE OWNER HAS FIRST RIGHT TO REFUSAL FOR SALVAGEABLE ITEMS. RELOCATED SUCH SALVAGED ITEMS TO STORAGE LOCATION AS OWNER MAY DESIGNATE WITHIN PROJECT
- 23. ALL EXISTING MOVABLE FURNITURE/EQUIPMENT WILL BE MOVED BY OWNER PRIOR TO CONSTRUCTION UNLESS OTHERWISE NOTED.
- 24. DEMOLITION ITEMS SHALL INCLUDE, BUT NOT BE LIMITED TO ITEMS IDENTIFIED ON THESE DRAWINGS. CONTRACTOR SHALL VISIT THE SITE PRIOR TO BIDDING AND BE FAMILIAR

KEYNOTE LEGEND:

< < < INDICATES KEYNOTE ON PLAN</p>

WITH THE WORK REQUIRED.

AD 01 DEMOLISH EXISTING WALL PARTITION IN ITS ENTIRETY.

AD 02 DEMOLISH PORTION OF WALL PARTITION AND FINISHES AS NEEDED TO ACCOMMODAT NEW OPENING.

AD 03 DEMOLISH DOOR & FRAME IN THEIR ENTIRETY.

AD 04 DEMOLISH CASEWORK IN ITS ENTIRETY, COORDINATE WITH MECH FOR REMOVAL OF PLUMBING WHERE APPLICABLE.

AD 05 DEMOLISH EXISTING WINDOW AND SLATE SILL IN THEIR ENTIRETY.

AD 06 DEMOLISH EXISTING WALL FINISHES IN THEIR ENTIRETY. PREPARE WALLS TO RECEIVE NEW FINISHES.

AD 07 DEMOLISH CEILING, FRAMING & CEILING-MOUNTED FIXTURES IN THEIR ENTIRETY. SEE MECH & ELEC FOR EXTENTS OF RELATED SYSTEMS DEMOLITION

AD 08 REMOVE EXISTING PLUMBING AND ASSOCIATED WALL-MOUNTED ACCESSORIES IN THEIR ENTIRETY, SEE PLUMBING FOR EXTENTS OF RELATED SYSTEMS DEMOLITION

AD 09 REMOVE EXISTING PARTITION SYSTEM

AD 10 DEMOLISH PORTION OF FLOOR SLAB FOR PLUMBING INSTALLATION. COORDINATE EXACT SIZE AND LOCATIONS WITH MC. SEE A021 FOR SLAB INFILL.

AD 17 DEMOLISH EXISTING FLOORING AND BASE IN THEIR ENTIRETY. PREPARE FLOOR TO RECEIVE NEW FINISHES.

AD 18 DEMOLISH EXISTING RECESSED CERAMIC TILE AND ASSOCIATED MORTAR. PREP SURFACE TO RECIEVE NEW FINISHES.

AD 30 REMOVE ADDITIONAL TOPPING SLAB TO PROVIDE APPROPRIATE DRAINAGE AT NEW SHOWER.

AD 32 REMOVE EXISTING GLASS, INT. SILL, AND WDW AC UNIT. EXISTING FRAME TO REMAIN.

AD 33 REMOVE EXISTING ROOF DRAIN OUTLET AND CAP UNUSED ROOF DRAIN. INFILL COMPLETELY WITH SPRAY FOAM INSULATION.

AE 46 EXISTING ACCESS DOOR TO TUNNEL TO REMAIN.



Architecture Engineering
Interior Design Industrial

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SOUTH DAKOTA STATE UNIVERSITY

PROJECT DESCRIPTION

SWN 0509, WANETA HALL RENOVATE RESTROOMS (OSE# R0325--15X)

CITY	BROOKINGS
STATE	SD

ISSUE DATES

 1
 ADDENDUM 1
 03/21/2025

 CD
 CONSTRUCTION DOCUMENTS
 03/13/2025

 MARK
 DESCRIPTION
 DATE

PROJECT NO: 20246780

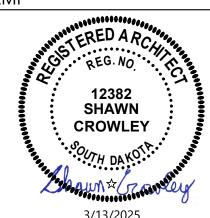
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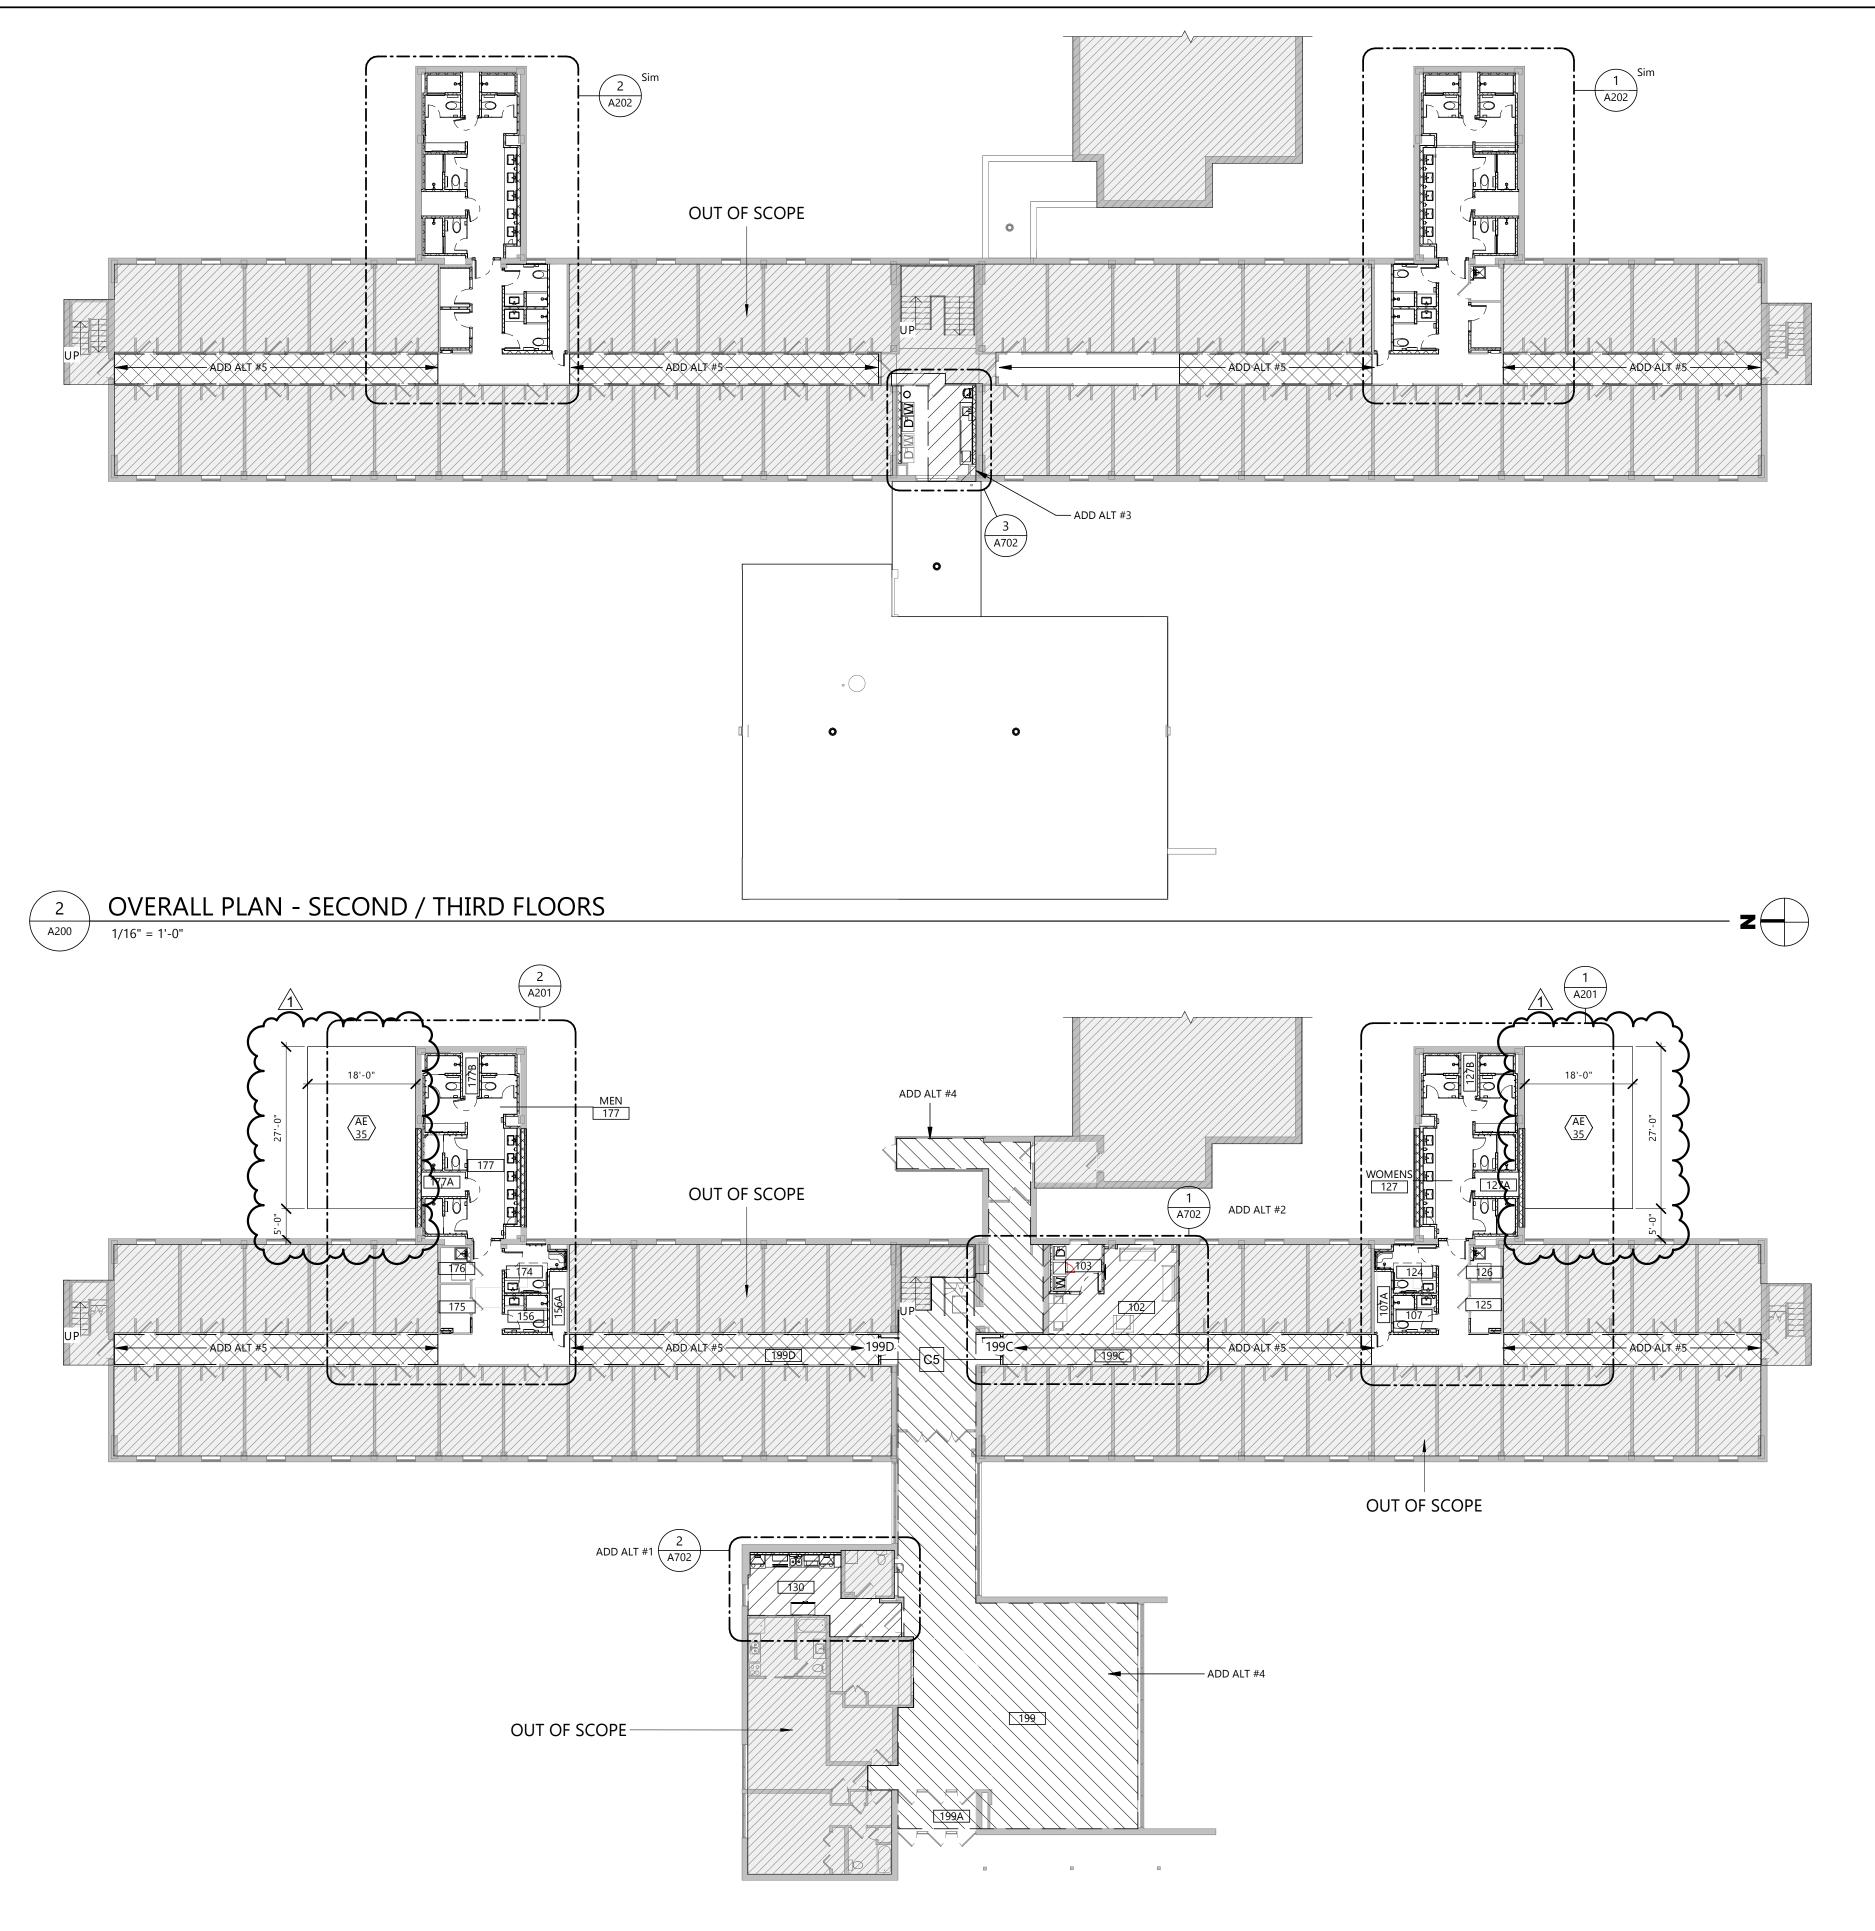
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DRAWING TITLE

DEMOLITION PLAN -FIRST FLOOR

A101



GENERAL NOTES

- 1. GENERAL NOTES APPLY TO ALL DRAWING SETS.
- 2. SUBCONTRACTORS FOR EACH TRADE ARE ADVISED THAT INFORMATION PERTINENT TO THEIR WORK MAY OCCUR IN OTHER PORTIONS OF THE CONTRACT DOCUMENTS. ALL NOTES ARE TO BE REVIEWED AND APPLIED TO RELATED BUILDINGS DOCUMENTS.
- FIELD VERIFY ALL DIMENSIONS AND EXISTING CONDITIONS. NOTIFY ARCHITECT IMMEDIATELY IF ANY CONFLICTS OR DISCREPANCIES OCCUR BEFORE AND / OR DURING CONSTRUCTION.
- 4. CROSS REFERENCES SHOWN ON DRAWINGS DO NOT NECESSARILY INDICATE ALL LIKE CONDITIONS AND DO NOT LIMIT APPLICATION OF ANY DRAWING OF DETAIL WHERE SPECIFIC DIMENSIONS, DETAILS, OR DESIGN INTENT CANNOT BE DETERMINED, CONSULT
- THE ARCHITECT PRIOR TO PROCEEDING WITH WORK.

 5. REVIEW SPECIFICATIONS FOR INSTRUCTIONS NOT SHOWN ON DRAWINGS. INFORMATION COMMON TO SEVERAL DRAWINGS MAY BE NOTED ON ONLY ONE. CONTRACTOR IS
- RESPONSIBLE FOR ENTIRE SET OF DOCUMENTS.

 6. ALL NEW CONSTRUCTION IS INDICATED BOLD OR FULL TONE.
- 7. DIMENSIONS AT INTERIOR PARTITIONS ARE TO THE CENTER OF THE WALL UNLESS NOTED OTHERWISE.
- 8. PROVIDE FIRE RETARDANT WOOD BACKING AND / OR BLOCKING IN WALLS AS REQUIRED AT ALL WALL MOUNTED ITEMS. AT EXISTING WALLS, REMOVE WALL MATERIAL TO INSTALL FIRE-TREATED WOOD BACKING/BLOCKING FOR NEW WALL-MOUNTED ITEMS.
- 9. DRAWINGS ARE NOT TO BE SCALED. CONTRACTOR TO VERIFY ALL DIMENSIONS & FIELD CONDITIONS PRIOR TO COMMENCING THE WORK.
- 10. REFER TO INTERIOR FINISH PLANS FOR CORNER GUARD LOCATIONS.
- 11. PATCH ALL HOLES IN EXISTING SURFACES & WHERE EQUIPMENT HAS BEEN REMOVED OR DEMOLITION HAS OCCURRED & PREPARE WALL SURFACES (PATCH, SKIM COAT, ETC.) AS REQUIRED IN PREPARATION FOR NEW FINISHES SCHEDULED. PATCH TO MATCH ADJACENT SURFACES IF NOT SCHEDULED.
- 12. CAULK ALL COUNTERTOPS, BACKSPLASHES & CABINETS AT LOCATIONS WHERE THEY MEET WALL. SEAL ALL CUT-OUTS IN COUNTERTOPS.
- 13. ALL EXISTING CONSTRUCTION, CABINET WORK, EQUIPMENT, ETC. TO REMAIN INDICATED AS LIGHT OR HALF TONE.
- 14. ALL PIPING, CONDUITS, & RELATED MECHANICAL & ELECTRICAL ITEMS SHALL BE CONCEALED WITHIN DRYWALL AND/OR PLASTER FURRING AS REQUIRED IN FINISHED AREAS WHETHER SHOWN ON DRAWINGS OR NOT UNLESS OTHERWISE NOTED.
- 15. SEAL AROUND ALL MECHANICAL & ELECTRICAL EQUIPMENT PENETRATIONS AT RATED WALLS, ABOVE & BELOW CEILINGS, WITH A UL APPROVED FIRE-STOPPING MATERIAL SEE SPECIFICATIONS.
- 16. WHEN WALL PARTITIONS OF DIFFERENT RATING INTERSECT, THE HIGHEST RATED PARTITIONS TAKE PRECEDENT.
- 17. ALL FURNITURE FOR REFERENCE ONLY (SHOWN DASHED) WILL BE OWNER FURNISHED & OWNER INSTALLED.
- 18. ERECT DUST PROOF PARTITIONS AS REQUIRED BY THE WORK ICRA TO PROTECT ADJACENT AREAS REFER TO SPEC SECTIONS 01 3532 AND 01 5615.
- 19. PROVIDE EASED EDGE AT COUNTERTOPS U.N.O.
- 20. ALL EXISTING FLOOR & WALL OPENING & DEPRESSIONS NOT USED IN THE NEW WORK SHALL BE FILLED OR CLOSED WITH MATERIALS TO MEET REQUIRED FIRE RATING & MATCH ADJACENT FINISHES.
- 21. ALL CUTTING & PATCHING REQUIRED FOR NEW MECHANICAL & ELECTRICAL WORK IN ALL EXISTING SPACES SHALL BE BY THE RESPECTIVE CONSTRUCTION.
- EXISTING SPACES SHALL BE BY THE RESPECTIVE CONSTRUCTION.

 22. MATCH FINISHED WALL THICKNESS WHERE NEW WALLS OCCUR IN LINE WITH EXISTING.
- 23. ALL EXISTING CEILING & WALL GRILLES, DIFFUSERS, & LIGHTS ETC. TO REMAIN IN AREAS OF CONSTRUCTION SHALL BE CLEANED.
- 24. VERIFY THAT THE EXISTING WALLS REQUIRING FIRE RATING ARE MAINTAINED, REPAIRED & EXTENDED TO STRUCTURE
- & EXTENDED TO STRUCTURE.

 25. ALL NEW WALLS ARE TYPE 'A5' WALL PARTITIONS UNLESS NOTED OTHERWISE. SEE WALL
- TYPES SHEET A021.

 26. REFER TO LIFE SAFETY PLANS AND FLOOR PLANS FOR LOCATION OF REQUIRED FIRE
- WALLS.

 27. REFER TO ELEVATIONS FOR WALL MOUNTED EQUIPMENT. PROVIDE IN-WALL BLOCKING
- AS REQUIRED.

 28. ALL COUNTERTOPS TO BE SSF-1 UNO, WITH THE EXCEPTION OF BATHROOMS TO BE
- 29. ALL CASEWORK TO BE PLAM-2 UNO.
- 30. TYPICAL ELEVATIONS APPLY TO ALL RESTROOM AND HALLWAY RESTROOM PODS.

KEYNOTE LEGEND:

< < INDICATES KEYNOTE ON PLAN
</p>

AE 35 CONCRETE ERU PAD TO BE PROVIDED BY G.C. 8" SLAB WITH #4 REBAR AT 12" OC EACH WAY AND THICKENED SLAB EDGES AT 14" DEEP BY 24" WIDE. PROVIDE 12" GRANULAR FILL, COMPACTED TO A MINIMUM OF 95% OF STANDARD PROTOR, BELOW SLAB. SLOPE CONCRETE AT 1/8" PER 12" AS INDICATED ON PLAN. SEE OVERALL PLAN ON A200 FOR DIMENSIONS TO BE INCLUDED ON BOTH WINGS OF THE BULDING.

MANNER WWW.



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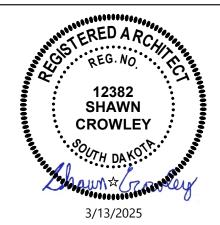
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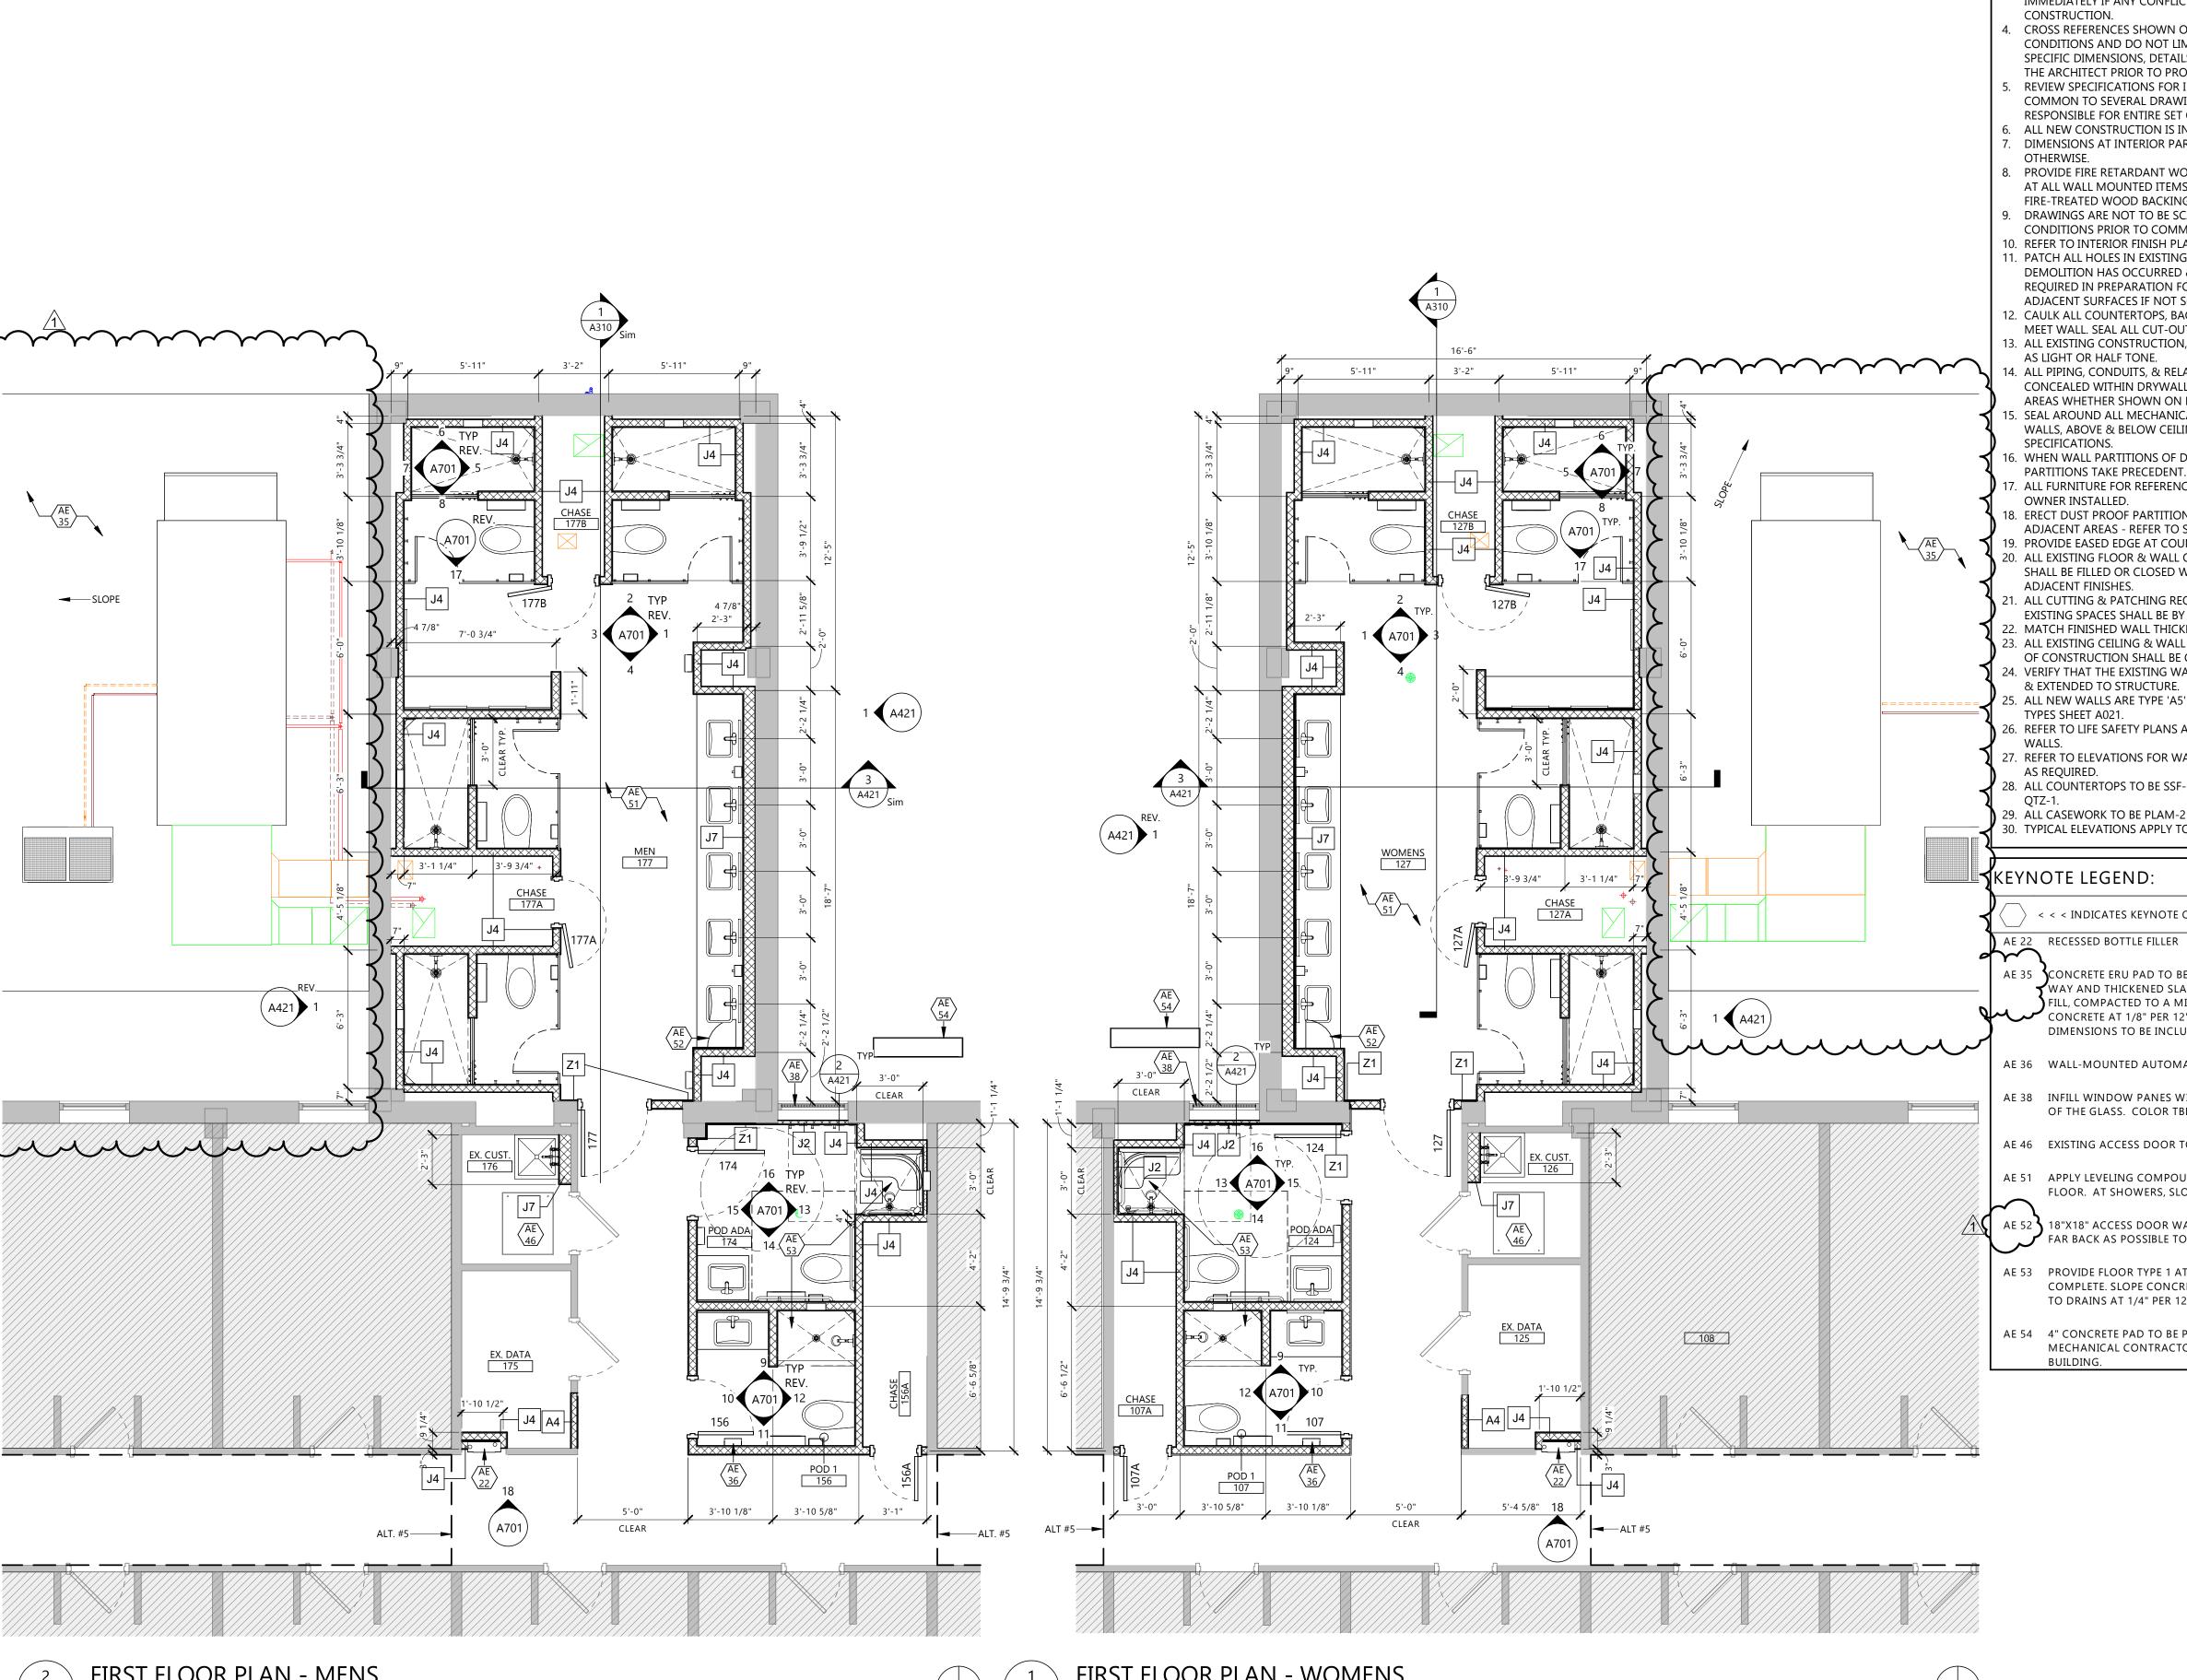
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DRAWING TITLE

OVERALL PLANS

A200



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- FIELD VERIFY ALL DIMENSIONS AND EXISTING CONDITIONS. NOTIFY ARCHITECT IMMEDIATELY IF ANY CONFLICTS OR DISCREPANCIES OCCUR BEFORE AND / OR DURING
- CROSS REFERENCES SHOWN ON DRAWINGS DO NOT NECESSARILY INDICATE ALL LIKE CONDITIONS AND DO NOT LIMIT APPLICATION OF ANY DRAWING OF DETAIL WHERE SPECIFIC DIMENSIONS, DETAILS, OR DESIGN INTENT CANNOT BE DETERMINED, CONSULT THE ARCHITECT PRIOR TO PROCEEDING WITH WORK.
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 - RESPONSIBLE FOR ENTIRE SET OF DOCUMENTS. ALL NEW CONSTRUCTION IS INDICATED BOLD OR FULL TONE.
- DIMENSIONS AT INTERIOR PARTITIONS ARE TO THE CENTER OF THE WALL UNLESS NOTED 8. PROVIDE FIRE RETARDANT WOOD BACKING AND / OR BLOCKING IN WALLS AS REQUIRED
- AT ALL WALL MOUNTED ITEMS. AT EXISTING WALLS, REMOVE WALL MATERIAL TO INSTALL FIRE-TREATED WOOD BACKING/BLOCKING FOR NEW WALL-MOUNTED ITEMS. DRAWINGS ARE NOT TO BE SCALED. CONTRACTOR TO VERIFY ALL DIMENSIONS & FIELD
- CONDITIONS PRIOR TO COMMENCING THE WORK. 10. REFER TO INTERIOR FINISH PLANS FOR CORNER GUARD LOCATIONS.
- 1. PATCH ALL HOLES IN EXISTING SURFACES & WHERE EQUIPMENT HAS BEEN REMOVED OR DEMOLITION HAS OCCURRED & PREPARE WALL SURFACES (PATCH, SKIM COAT, ETC.) AS REQUIRED IN PREPARATION FOR NEW FINISHES SCHEDULED. PATCH TO MATCH ADJACENT SURFACES IF NOT SCHEDULED.
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- 22. MATCH FINISHED WALL THICKNESS WHERE NEW WALLS OCCUR IN LINE WITH EXISTING.
- 23. ALL EXISTING CEILING & WALL GRILLES, DIFFUSERS, & LIGHTS ETC. TO REMAIN IN AREAS OF CONSTRUCTION SHALL BE CLEANED.
- 24. VERIFY THAT THE EXISTING WALLS REQUIRING FIRE RATING ARE MAINTAINED, REPAIRED & EXTENDED TO STRUCTURE.
- 25. ALL NEW WALLS ARE TYPE 'A5' WALL PARTITIONS UNLESS NOTED OTHERWISE. SEE WALL
- 26. REFER TO LIFE SAFETY PLANS AND FLOOR PLANS FOR LOCATION OF REQUIRED FIRE
- 27. REFER TO ELEVATIONS FOR WALL MOUNTED EQUIPMENT. PROVIDE IN-WALL BLOCKING
- 28. ALL COUNTERTOPS TO BE SSF-1 UNO, WITH THE EXCEPTION OF BATHROOMS TO BE
- 29. ALL CASEWORK TO BE PLAM-2 UNO.
- 30. TYPICAL ELEVATIONS APPLY TO ALL RESTROOM AND HALLWAY RESTROOM PODS.

KEYNOTE LEGEND:

< < < INDICATES KEYNOTE ON PLAN

ONCRETE ERU PAD TO BE PROVIDED BY G.C. 8" SLAB WITH #4 REBAR AT 12" OC EACH WAY AND THICKENED SLAB EDGES AT 14" DEEP BY 24" WIDE. PROVIDE 12" GRANULAR FILL, COMPACTED TO A MINIMUM OF 95% OF STANDARD PROTOR, BELOW SLAB. SLOPE CONCRETE AT 1/8" PER 12" AS INDICATED ON PLAN. SEE OVERALL PLAN ON A200 FOR DIMENSIONS TO BE INCLUDED ON BOTH WINGS OF THE BULDING.

- AE 36 WALL-MOUNTED AUTOMATIC HAND DRYER
- AE 38 INFILL WINDOW PANES WITH INSULATED MAPES PANELS THAT MATCH THE THICKNESS OF THE GLASS. COLOR TBD.
- AE 46 EXISTING ACCESS DOOR TO TUNNEL TO REMAIN.
- AE 51 APPLY LEVELING COMPOUND THROUGHOUT ROOM PRIOR TO INSTALLING FINISH FLOOR. AT SHOWERS, SLOPE FLOORING 1/4" PER 12" TO MAINTAIN PROPER DRAINAGE.
 - 18"X18" ACCESS DOOR WALL-MOUNTED BELOW COUNTERTOP. MOUNT AS HIGH AND FAR BACK AS POSSIBLE TO MINIMIZE VISIBILITY. PAINT.
- AE 53 PROVIDE FLOOR TYPE 1 AT DEMOLISHED SLAB AREAS AFTER PLUMBING WORK IS COMPLETE. SLOPE CONCRETE OR APPLY LEVELING COMPOUND AT SHOWERS TO SLOPE TO DRAINS AT 1/4" PER 12".
- AE 54 4" CONCRETE PAD TO BE PROVIDED BY G.C. COORDINATE SIZE AND LOCATION WITH MECHANICAL CONTRACTOR. SLOPE CONCRETE AT 1/4" PER 12" AS AWAY FROM BUILDING.

Architecture Engineering

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101 N. Phillips Ave., Ste. 300, Sioux Falls, SD 57104

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SOUTH DAKOTA STATE UNIVERSITY

PROJECT DESCRIPTION

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CITY	BROOKINGS
STATE	SD


ISSUE DATES

1	ADDENDUM 1	03/21/2025
	CONSTRUCTION DOCUMENTS	03/13/2025
MARK	DESCRIPTION	DATE
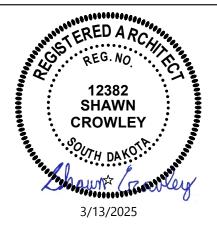
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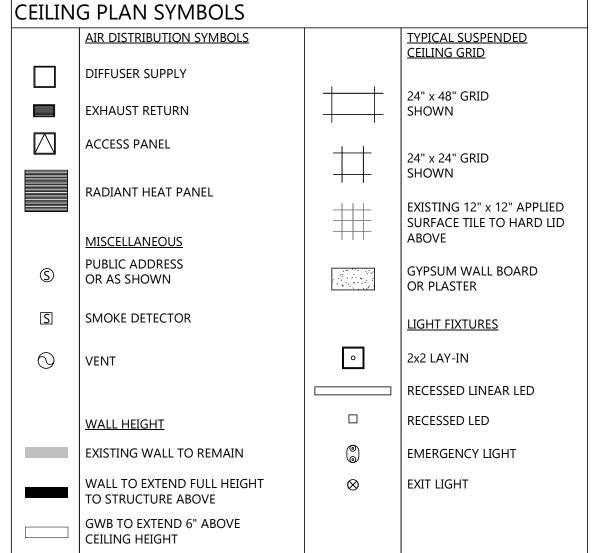
FIRST FLOOR PLAN

A201

1/4" = 1'-0"



- PROVIDE GYPSUM WALL BOARD AND METAL STUD BULK HEADS WHERE CEILINGS OF DIFFERENT HEIGHTS ABUT. DO NOT BUILD BULKHEADS OF ACOUSTICAL CEILING MATERIALS UNLESS SPECIFICALLY DETAILED.
- REFER TO MECHANICAL DRAWINGS FOR QUANTITY AND TYPE OF DIFFUSERS, RETURN GRILLES AND EXHAUST GRILLES, ETC. SCRIBE CEILING MATERIALS FOR A TIGHT FIT.
- REFER TO ELECTRICAL DRAWINGS FOR QUANTITY AND TYPE OF LIGHTS, SPEAKERS, DETECTORS, POWER OUTLETS, ETC. SCRIBE CEILING MATERIALS FOR A TIGHT FIT. WHERE DEVICES ARE NOT SHOWN ON PLAN, FIELD VERIFY LOCATION AND QUANTITY PRIOR TO REMOVAL. THESE DEVICES WILL BE RELOCATED INTO NEW PLAN.
- FIRE SPRINKLER CONTRACTOR IS REQUIRED TO PROVIDE FINAL DESIGN OF ENTIRE SPRINKLER SYSTEM FOR THE PROJECT AREA. SPRINKLER CONTRACTOR IS REQUIRED TO
- SUBMIT ALL REQUIRED INFORMATION TO REVIEW AGENCIES FOR APPROVAL AND PERMITS. CONTRACTOR TO FIELD VERIFY EXTENT OF CEILING REPLACEMENT. CONTRACTOR TO COORDINATE WITH ALL TRADES. CONTRACTORS OPTION TO REPLACE CEILING TO OWNER'S SATISFACTION OR TO PROVIDE NEW CEILING MATERIAL REPAIR ANY EXISTING
- AREAS DAMAGED BY CONSTRUCTION OF THIS PROJECT. WHERE CEILINGS ARE INDICATED TO BE EXPOSED TO STRUCTURE, PAINT ALL UNFINISHED MATERIALS OVERHEAD UNO. INCLUDING, BUT NOT LIMITED TO; ROOF DECKING, JOISTS, DUCTS, PIPING, CONDUIT, ETC. SEE FINISHES SHEET FOR PAINT.
- GENERAL CONTRACTOR TO COORDINATE CEILING MOUNTED EQUIPMENT SUPPORT REQUIREMENTS, LOCATIONS, DIMENSIONS, ETC. WITH EQUIPMENT SUPPLER AND OWNER PRIOR TO INSTALLATION.
- CEILING MOUNTED ITEMS SUCH AS LIGHT FIXTURES, GRILLES, DIFFUSERS, SPEAKERS, EXIT LIGHTS, ETC. SHALL BE LOCATED IN THE CENTER OF CEILING PANELS, GYPSUM BOARD SOFFITS, AND/OR PLASTER SOFFIT BAYS UNLESS NOTED OTHERWISE. COORDINATE WITH MECHANICAL AND ELECTRICAL DRAWINGS.
- FINISHED GYPSUM BOARD SOFFITS SHALL EXTEND 1" BEYOND FACE AND EXPOSED ENDS OF WALL CABINETS, FULL-HEIGHT CABINETS, ETC. UNLESS NOTED OTHERWISE. COORDINATE CABINET DIMENSIONS WITH SUPPLIER GYPSUM BOARD FASCIA/SOFFIT DETAILS ARE REFERENCED FROM THE REFLECTED CEILING PLAN.
-). In remodeling work in existing acoustic ceiling tile suspension system remove EXISTING PANELS, CUT AS REQUIRED FOR CONSTRUCTION, AND REINSTALL, REPLACE
- DAMAGED OR SOILED PANELS WITH ACOUSTIC CEILING TILE TO MATCH EXISTING. . VERTICAL FACE OF SOFFITS THAT ALIGN WITH WALL TO RECEIVE ADJACENT WALL FINISH UNLESS NOTED OTHERWISE.
- 2. PROVIDE SMOOTH TRANSITION BETWEEN EXISTING AND NEW GYP BD CEILING WHERE NEW GYP BD MEETS EXISTING AT SAME HEIGHT (NO VISIBLE JOINT BETWEEN EXISTING AND
- 13. UNISTRUT TO BE DESIGN BUILD. COORDINATE CLOSELY WITH EQUIPMENT DRAWINGS FOR LOCATIONS OF ALL LIGHTS AND BOOMS.
- 14. ACCESS PANELS SIZE, LOCATION AND QUANTITY COORDINATE WITH MECHANICAL.
- 15. ALL GYPSUM CEILINGS SHALL BE SUPPORTED USING A TEE SUSPENSION TO MINIMIZE DEPTH OF SYSTEM.



KEYNOTE LEGEND:

< < < INDICATES KEYNOTE ON PLAN

AE 02 EXISTING CEILING TO REMAIN. PATCH AND REPAIR AS REQUIRED FOR NEW

EXPOSED CEILING STRUCTURE AND MATERIALS ABOVE TO REMAIN UNPAINTED, INCLUDING DECKING, JOISTS, DUCTS, PIPING, AND CONDUIT.

AE 12 SHOWER CURTAIN ROD SYSTEM

AE 26 EXTEND EXISTING WALL TO DECK AND SEAL TO MAINTAIN RATING

Architecture

TELE 605.444.1600 FAX 605.444.1601 101 N. Phillips Ave., Ste. 300, Sioux Falls, SD 57104

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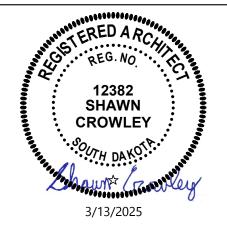
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STATE	SD
ISSUE DATES	

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1	ADDENDUM 1		03/21/2025
CD	CONSTRUCTION DOCUMENTS	Z	03/13/2025
MARK	DESCRIPTION		DATE

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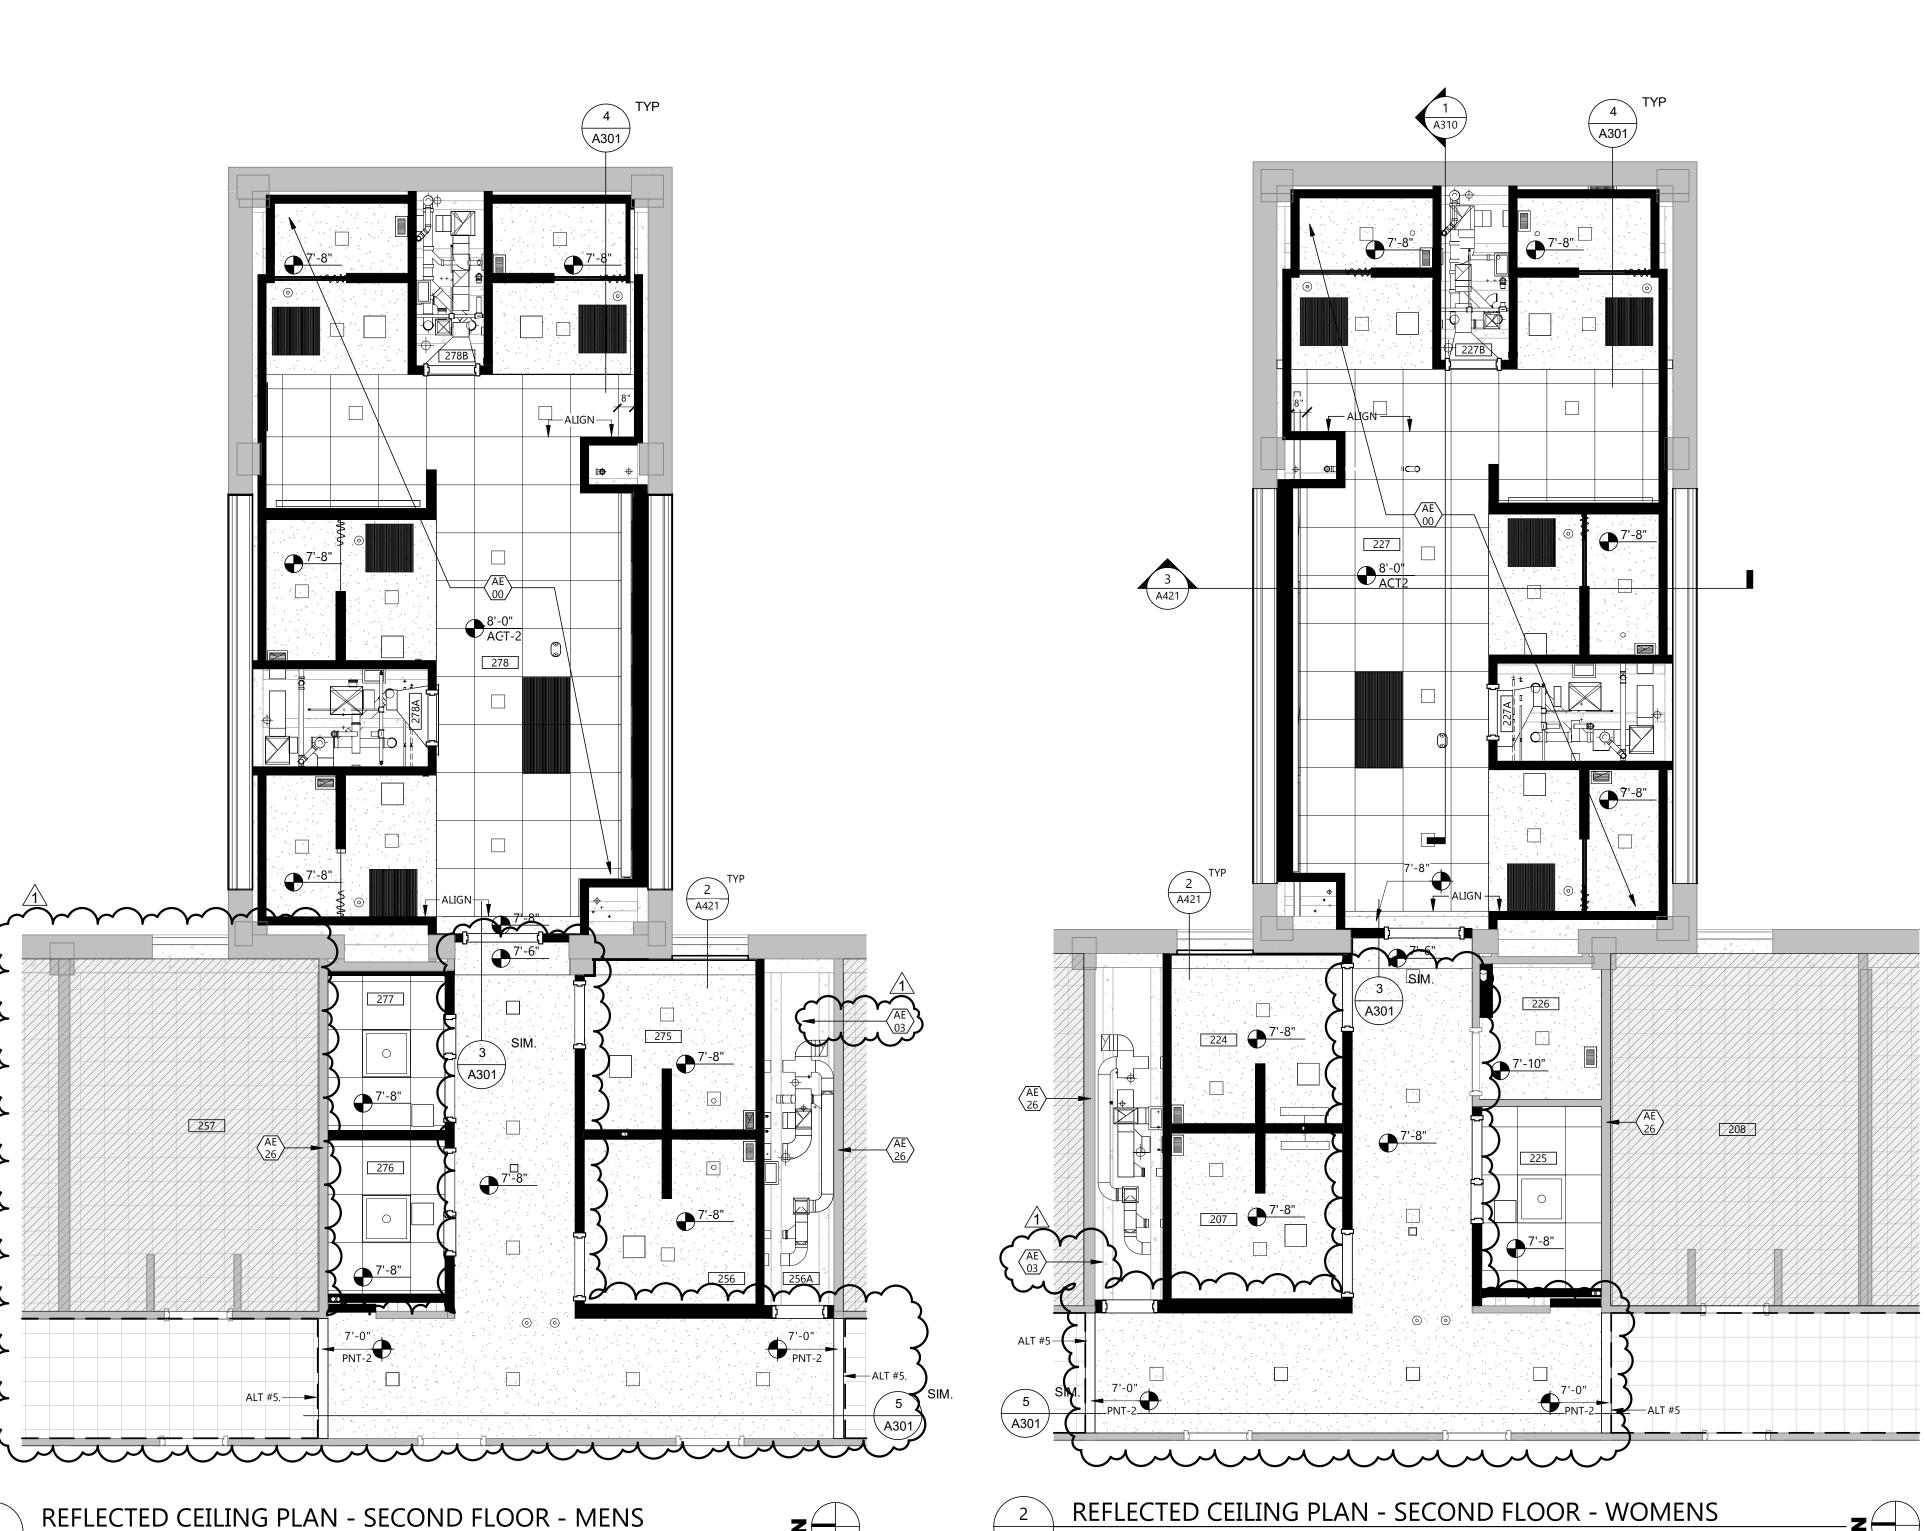
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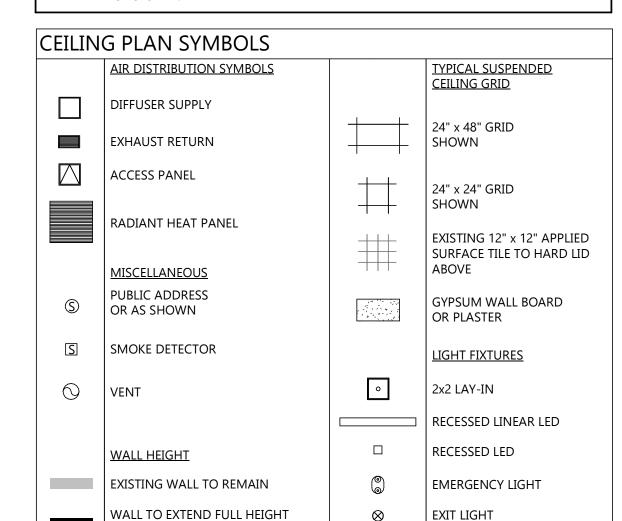
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REFLECTED CEILING PLAN - FIRST FLOOR

A301



- PROVIDE GYPSUM WALL BOARD AND METAL STUD BULK HEADS WHERE CEILINGS OF DIFFERENT HEIGHTS ABUT. DO NOT BUILD BULKHEADS OF ACOUSTICAL CEILING MATERIALS UNLESS SPECIFICALLY DETAILED.
- REFER TO MECHANICAL DRAWINGS FOR QUANTITY AND TYPE OF DIFFUSERS, RETURN GRILLES AND EXHAUST GRILLES, ETC. SCRIBE CEILING MATERIALS FOR A TIGHT FIT.
- REFER TO ELECTRICAL DRAWINGS FOR QUANTITY AND TYPE OF LIGHTS, SPEAKERS, DETECTORS, POWER OUTLETS, ETC. SCRIBE CEILING MATERIALS FOR A TIGHT FIT. WHERE DEVICES ARE NOT SHOWN ON PLAN, FIELD VERIFY LOCATION AND QUANTITY PRIOR TO REMOVAL. THESE DEVICES WILL BE RELOCATED INTO NEW PLAN.
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- AREAS DAMAGED BY CONSTRUCTION OF THIS PROJECT. 6. WHERE CEILINGS ARE INDICATED TO BE EXPOSED TO STRUCTURE, PAINT ALL UNFINISHED MATERIALS OVERHEAD UNO. INCLUDING, BUT NOT LIMITED TO; ROOF DECKING, JOISTS, DUCTS, PIPING, CONDUIT, ETC. SEE FINISHES SHEET FOR PAINT.
- GENERAL CONTRACTOR TO COORDINATE CEILING MOUNTED EQUIPMENT SUPPORT REQUIREMENTS, LOCATIONS, DIMENSIONS, ETC. WITH EQUIPMENT SUPPLER AND OWNER PRIOR TO INSTALLATION. CEILING MOUNTED ITEMS SUCH AS LIGHT FIXTURES, GRILLES, DIFFUSERS, SPEAKERS, EXIT
- LIGHTS, ETC. SHALL BE LOCATED IN THE CENTER OF CEILING PANELS, GYPSUM BOARD SOFFITS, AND/OR PLASTER SOFFIT BAYS UNLESS NOTED OTHERWISE. COORDINATE WITH MECHANICAL AND ELECTRICAL DRAWINGS.
- FINISHED GYPSUM BOARD SOFFITS SHALL EXTEND 1" BEYOND FACE AND EXPOSED ENDS OF WALL CABINETS, FULL-HEIGHT CABINETS, ETC. UNLESS NOTED OTHERWISE. COORDINATE CABINET DIMENSIONS WITH SUPPLIER GYPSUM BOARD FASCIA/SOFFIT DETAILS ARE REFERENCED FROM THE REFLECTED CEILING PLAN.
- 0. In remodeling work in existing acoustic ceiling tile suspension system remove EXISTING PANELS, CUT AS REQUIRED FOR CONSTRUCTION, AND REINSTALL, REPLACE DAMAGED OR SOILED PANELS WITH ACOUSTIC CEILING TILE TO MATCH EXISTING.
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- 14. ACCESS PANELS SIZE, LOCATION AND QUANTITY COORDINATE WITH MECHANICAL. 15. ALL GYPSUM CEILINGS SHALL BE SUPPORTED USING A TEE SUSPENSION TO MINIMIZE DEPTH OF SYSTEM.



KEYNOTE LEGEND:

< < INDICATES KEYNOTE ON PLAN
</p>

CEILING HEIGHT

TO STRUCTURE ABOVE

GWB TO EXTEND 6" ABOVE

AE 00 SEE FIRST FLOOR PLAN ON A201 AND FIRST FLOOR REFLECTED CEILING PLAN ON A301 FOR ALL DIMENSIONS, KEYNOTES, WALL TAGS AND REFERENCES IN THIS AREA.

AE 26 EXTEND EXISTING WALL TO DECK AND SEAL TO MAINTAIN RATING

EXPOSED CEILING STRUCTURE AND MATERIALS ABOVE TO REMAIN UNPAINTED, INCLUDING DECKING, JOISTS, DUCTS, PIPING, AND CONDUIT.

Architecture Engineering Interior Design

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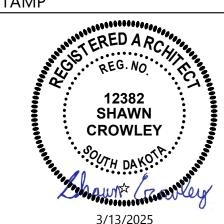
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DRAWING TITLE

REFLECTED CEILING PLAN - SECOND **FLOOR**

A302

A302 /

1/4" = 1'-0"



- 1. PROVIDE GYPSUM WALL BOARD AND METAL STUD BULK HEADS WHERE CEILINGS OF DIFFERENT HEIGHTS ABUT. DO NOT BUILD BULKHEADS OF ACOUSTICAL CEILING MATERIALS UNLESS SPECIFICALLY DETAILED.
- 2. REFER TO MECHANICAL DRAWINGS FOR QUANTITY AND TYPE OF DIFFUSERS, RETURN GRILLES AND EXHAUST GRILLES, ETC. SCRIBE CEILING MATERIALS FOR A TIGHT FIT.
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- SUBMIT ALL REQUIRED INFORMATION TO REVIEW AGENCIES FOR APPROVAL AND PERMITS.

 5. CONTRACTOR TO FIELD VERIFY EXTENT OF CEILING REPLACEMENT. CONTRACTOR TO COORDINATE WITH ALL TRADES. CONTRACTORS OPTION TO REPLACE CEILING TO OWNER'S SATISFACTION OR TO PROVIDE NEW CEILING MATERIAL REPAIR ANY EXISTING AREAS DAMAGED BY CONSTRUCTION OF THIS PROJECT.
- 6. WHERE CEILINGS ARE INDICATED TO BE EXPOSED TO STRUCTURE, PAINT ALL UNFINISHED MATERIALS OVERHEAD UNO. INCLUDING, BUT NOT LIMITED TO; ROOF DECKING, JOISTS, DUCTS, PIPING, CONDUIT, ETC. SEE FINISHES SHEET FOR PAINT.
 7. GENERAL CONTRACTOR TO COORDINATE CEILING MOUNTED EQUIPMENT SUPPORT
- REQUIREMENTS, LOCATIONS, DIMENSIONS, ETC. WITH EQUIPMENT SUPPLER AND OWNER PRIOR TO INSTALLATION.

 8. CEILING MOUNTED ITEMS SUCH AS LIGHT FIXTURES, GRILLES, DIFFUSERS, SPEAKERS, EXIT LIGHTS, ETC. SHALL BE LOCATED IN THE CENTER OF CEILING PANELS, GYPSUM BOARD

SOFFITS, AND/OR PLASTER SOFFIT BAYS UNLESS NOTED OTHERWISE. COORDINATE WITH

- MECHANICAL AND ELECTRICAL DRAWINGS.

 9. FINISHED GYPSUM BOARD SOFFITS SHALL EXTEND 1" BEYOND FACE AND EXPOSED ENDS OF WALL CABINETS, FULL-HEIGHT CABINETS, ETC. UNLESS NOTED OTHERWISE.

 COORDINATE CABINET DIMENSIONS WITH SUPPLIER GYPSUM BOARD FASCIA/SOFFIT
- COORDINATE CABINET DIMENSIONS WITH SUPPLIER GYPSUM BOARD FASCIA/SOFFIT DETAILS ARE REFERENCED FROM THE REFLECTED CEILING PLAN.

 10. IN REMODELING WORK IN EXISTING ACOUSTIC CEILING TILE SUSPENSION SYSTEM REMOVE EXISTING PANELS, CUT AS REQUIRED FOR CONSTRUCTION, AND REINSTALL, REPLACE
- DAMAGED OR SOILED PANELS WITH ACOUSTIC CEILING TILE TO MATCH EXISTING.

 11. VERTICAL FACE OF SOFFITS THAT ALIGN WITH WALL TO RECEIVE ADJACENT WALL FINISH UNLESS NOTED OTHERWISE.
- 12. PROVIDE SMOOTH TRANSITION BETWEEN EXISTING AND NEW GYP BD CEILING WHERE NEW GYP BD MEETS EXISTING AT SAME HEIGHT (NO VISIBLE JOINT BETWEEN EXISTING AND
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- ACCESS PANELS SIZE, LOCATION AND QUANTITY COORDINATE WITH MECHANICAL.
 ALL GYPSUM CEILINGS SHALL BE SUPPORTED USING A TEE SUSPENSION TO MINIMIZE DEPTH OF SYSTEM.

CEILING PLAN SYMBOLS

CLILII	G I E/ (I V S I I VIDO E S		<u></u>
	AIR DISTRIBUTION SYMBOLS		TYPICAL SUSPENDED CEILING GRID
	DIFFUSER SUPPLY		
	EXHAUST RETURN		24" x 48" GRID SHOWN
	ACCESS PANEL	++	24" x 24" GRID
	RADIANT HEAT PANEL	++	SHOWN
	RADIANT REAT FANCE		EXISTING 12" x 12" APPLIED SURFACE TILE TO HARD LID
	MISCELLANEOUS		ABOVE
(\$)	PUBLIC ADDRESS OR AS SHOWN		GYPSUM WALL BOARD OR PLASTER
S	SMOKE DETECTOR		LIGHT FIXTURES
\bigcirc	VENT	•	2x2 LAY-IN
			RECESSED LINEAR LED
	WALL HEIGHT		RECESSED LED
	EXISTING WALL TO REMAIN		EMERGENCY LIGHT
	WALL TO EXTEND FULL HEIGHT TO STRUCTURE ABOVE	8	EXIT LIGHT
		ı	

KEYNOTE LEGEND:

< < < INDICATES KEYNOTE ON PLAN</p>

CEILING HEIGHT

GWB TO EXTEND 6" ABOVE

AE 00 SEE FIRST FLOOR PLAN ON A201 AND FIRST FLOOR REFLECTED CEILING PLAN ON A301 FOR ALL DIMENSIONS, KEYNOTES, WALL TAGS AND REFERENCES IN THIS AREA.

1 AE 03 E

EXPOSED CEILING STRUCTURE AND MATERIALS ABOVE TO REMAIN UNPAINTED, INCLUDING DECKING, JOISTS, DUCTS, PIPING, AND CONDUIT.

AE 26 EXTEND EXISTING WALL TO DECK AND SEAL TO MAINTAIN RATING

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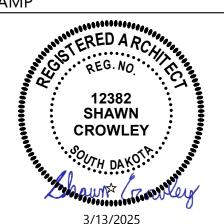
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REFLECTED CEILING PLAN - THIRD FLOOR

A303



- PROVIDE GYPSUM WALL BOARD AND METAL STUD BULK HEADS WHERE CEILINGS OF DIFFERENT HEIGHTS ABUT. DO NOT BUILD BULKHEADS OF ACOUSTICAL CEILING MATERIALS UNLESS SPECIFICALLY DETAILED.
- 2. REFER TO MECHANICAL DRAWINGS FOR QUANTITY AND TYPE OF DIFFUSERS, RETURN GRILLES AND EXHAUST GRILLES, ETC. SCRIBE CEILING MATERIALS FOR A TIGHT FIT.
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 COORDINATE CABINET DIMENSIONS WITH SUPPLIER GYPSUM BOARD FASCIA/SOFFIT DETAILS ARE REFERENCED FROM THE REFLECTED CEILING PLAN
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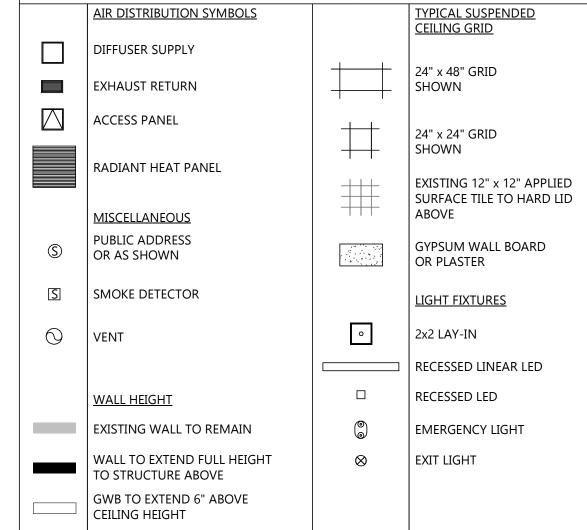
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CEILING PLAN SYMBOLS

DEPTH OF SYSTEM.



KEYNOTE LEGEND:

CONSTRUCTION.

< < < INDICATES KEYNOTE ON PLAN</p>
AE 02 EXISTING CEILING TO REMAIN. PATCH AND REPAIR AS REQUIRED FOR NEW

AE 17 OVEN WITH OVERHEAD HOOD BY OWNER. SEE MECHANICAL FOR REQUIREMENTS.

AE 26 EXTEND EXISTING WALL TO DECK AND SEAL TO MAINTAIN RATING

AE 27 EXTEND SOFFIT / BULKHEAD TO DECK AND SEAL TO MAINTAIN RATING

AE 28 EXISTING SOFFIT / BULKHEAD TO REMAIN

AE 40 SHIPS LADDER

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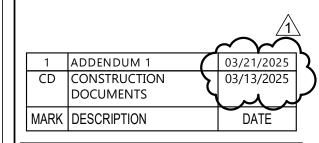
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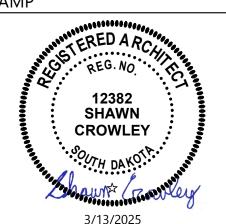
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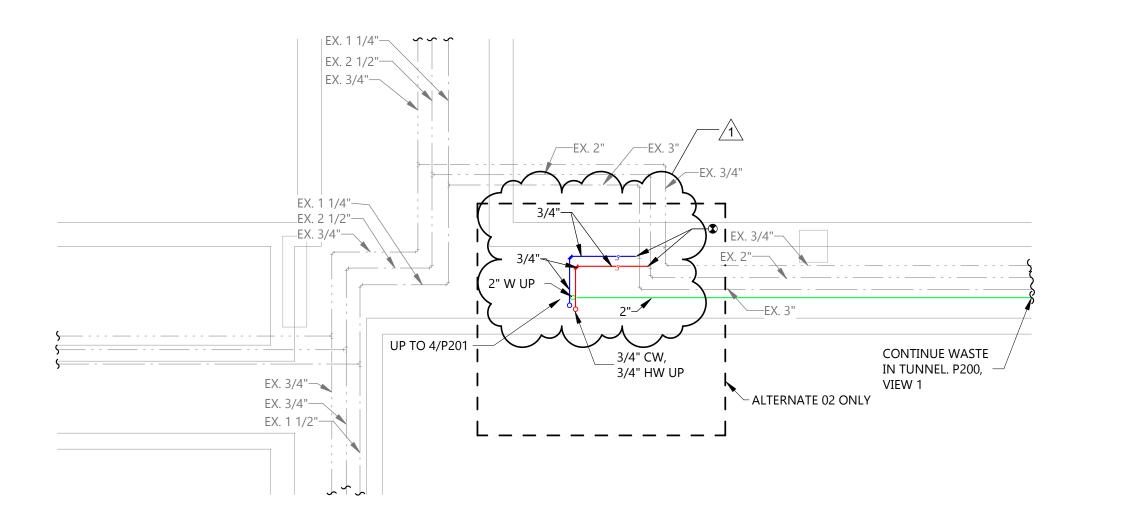
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REFLECTED CEILING
PLAN - ADD
ALTERNATES

A304



UNDERGROUND/TUNNEL PLUMBING PLAN - LAUNDRY ROOM (ALT. 02)

1" CW, 1" HW,

EX. 2"

KEYNOTE LEGEND:

< < < INDICATES KEYNOTE ON PLAN
</p>

PL 01 2" WASTE UP TO SHOWER DRAIN

PL 02 4" WASTE UP TO WATER CLOSET CARRIER

PL 03 2" WASTE UP TO FLOOR DRAIN

PL 05 3/4" CW UP TO WALL HYDRANT

PL 04 2" WASTE UP TO SINK

PL 06 3" WASTE UP TO MB

1-1/2" V UP -

_ 2-1/2" CW, 1" HW, 3/4" HWR UP

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TELE 605.444.1600 FAX 605.444.1601

101 N. Phillips Ave., Ste. 300, Sioux Falls, SD 57104

PROJECT DESCRIPTION

SWN 0509, WANETA HALL RENOVATE RESTROOMS (OSE#R0325--15X)

BROOKINGS CITY STATE

ISSUE DATES

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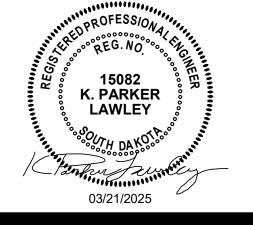
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2-1/2" CW, 1" HW,

-3/4" CW, 3/4" HW,

3/4" HWR UP

3/4" HWR UP

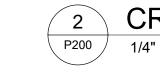


DRAWING TITLE CRAWL SPACE PLUMBING PLANS

P200

CRAWL SPACE PLUMBING PLANS - MENS







9 P200

2-1/2" CW, 1" HW, 3/4" HWR UP

2" V UP -

3/4" CW, 3/4" HW, 3/4" HWR UP

4" W UP -1-1/2" V UP 1-1/2" V UP

2-1/2" CW, 1" HW, 3/4" HWR UP

∕− 1-1/2" V UP



2-1/2" CW, 1" HW, 2-1/2" CW, 1" HW, ____ 3/4" HWR UP

1" CW, 1" HW,

3/4" HWR UP -


└─EX. 2"

└─EX. 3"

ONLY

ALTERNATE 02

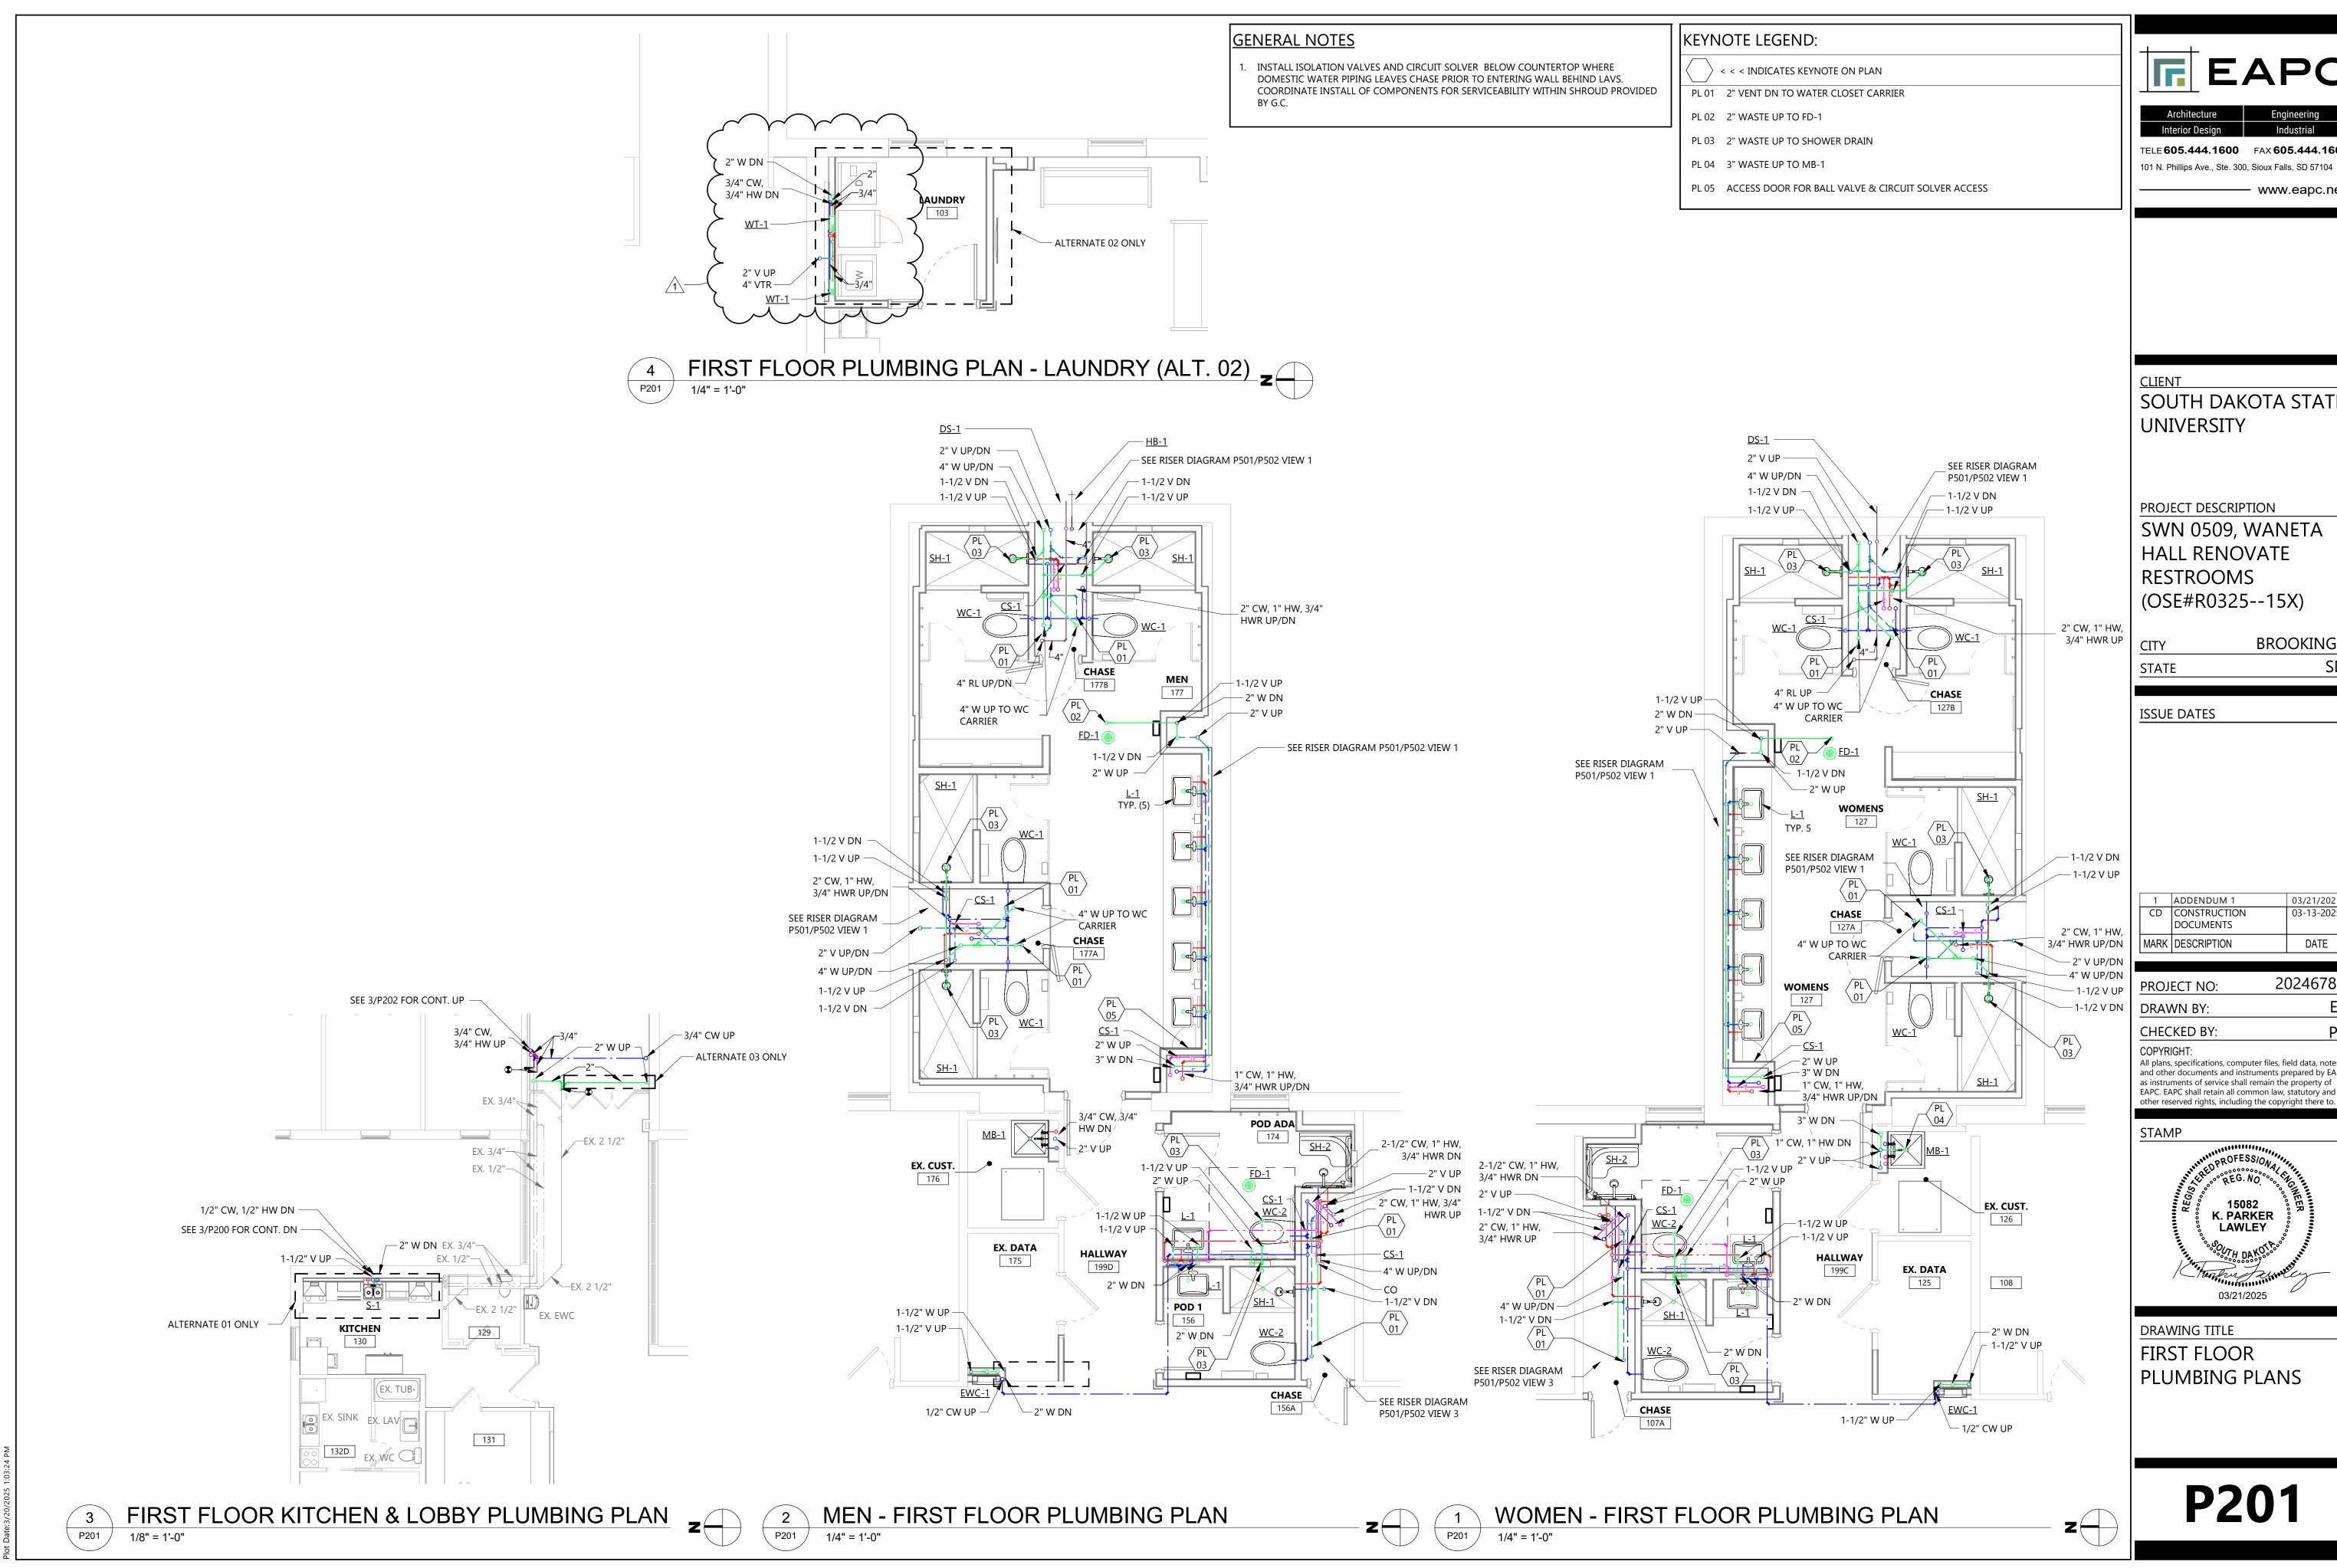WASTE CONTINUED FROM VIEW 4, P200



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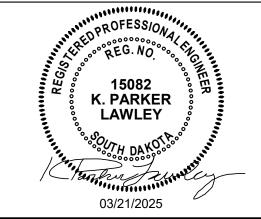
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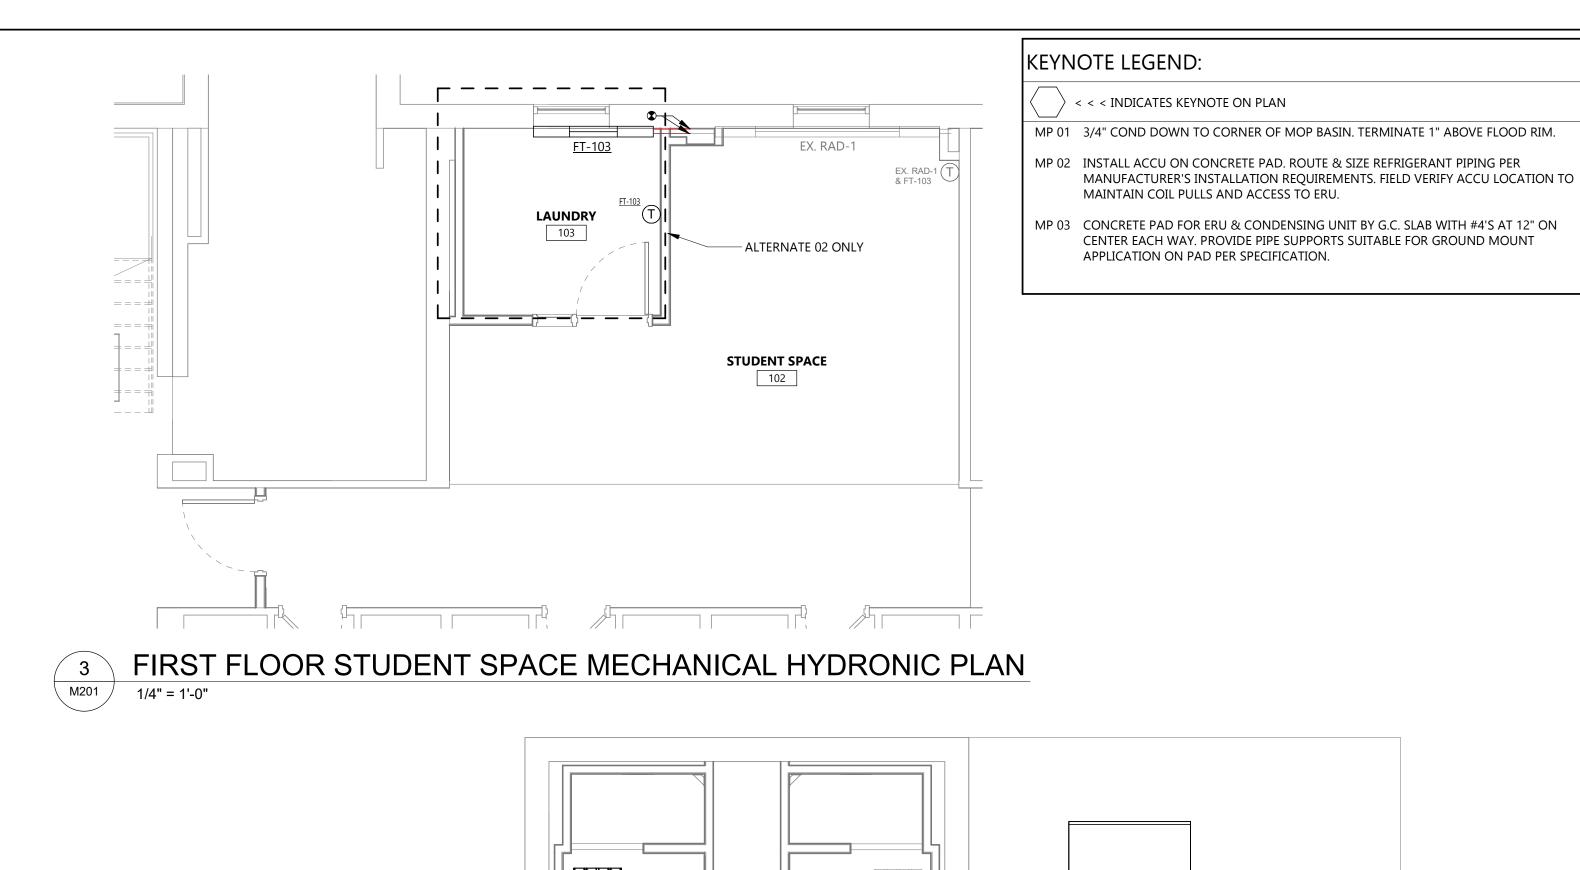
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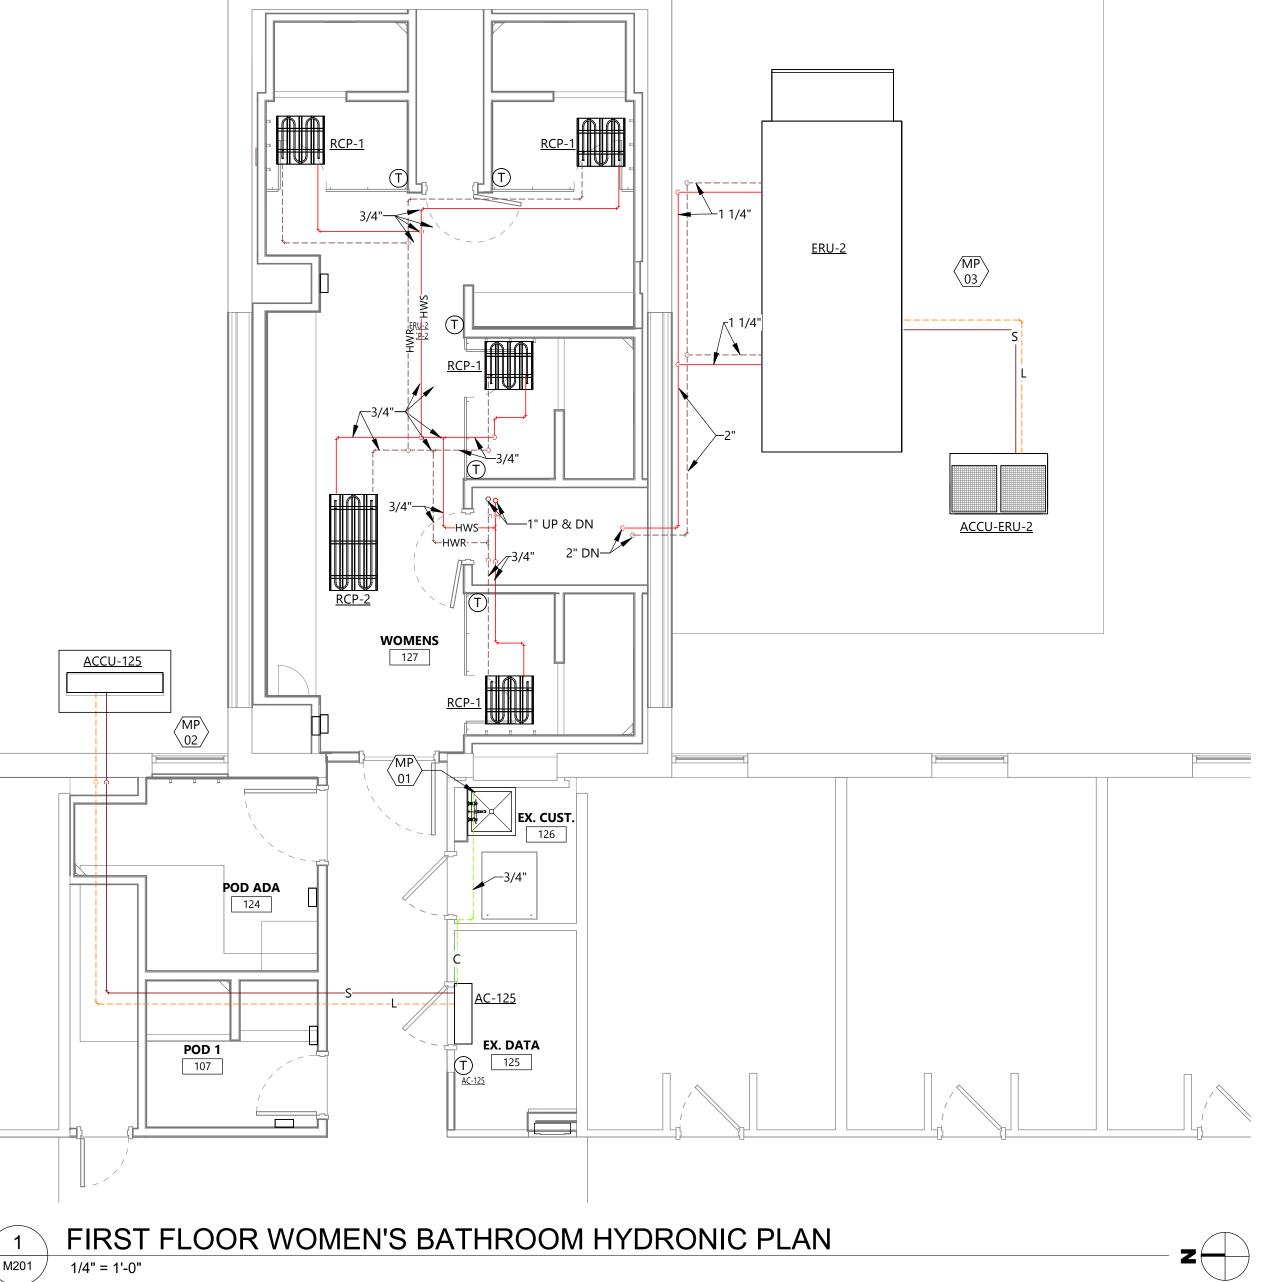
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DRAWING TITLE FIRST FLOOR PLUMBING PLANS

P201





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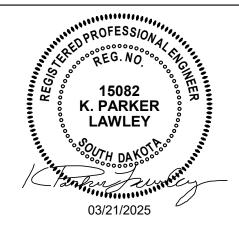
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DRAWING TITLE FIRST FLOOR HYDRONICS PLANS

M201

FIRST FLOOR MEN'S BATHROOM HYDRONIC PLAN M201 1/4" = 1'-0"

<u>ERU-1</u>



ACCU-175


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156

FIRST FLOOR WOMEN'S BATHROOM HYDRONIC PLAN






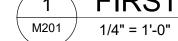EX. CUST. 176

EX. DATA

RCP-2

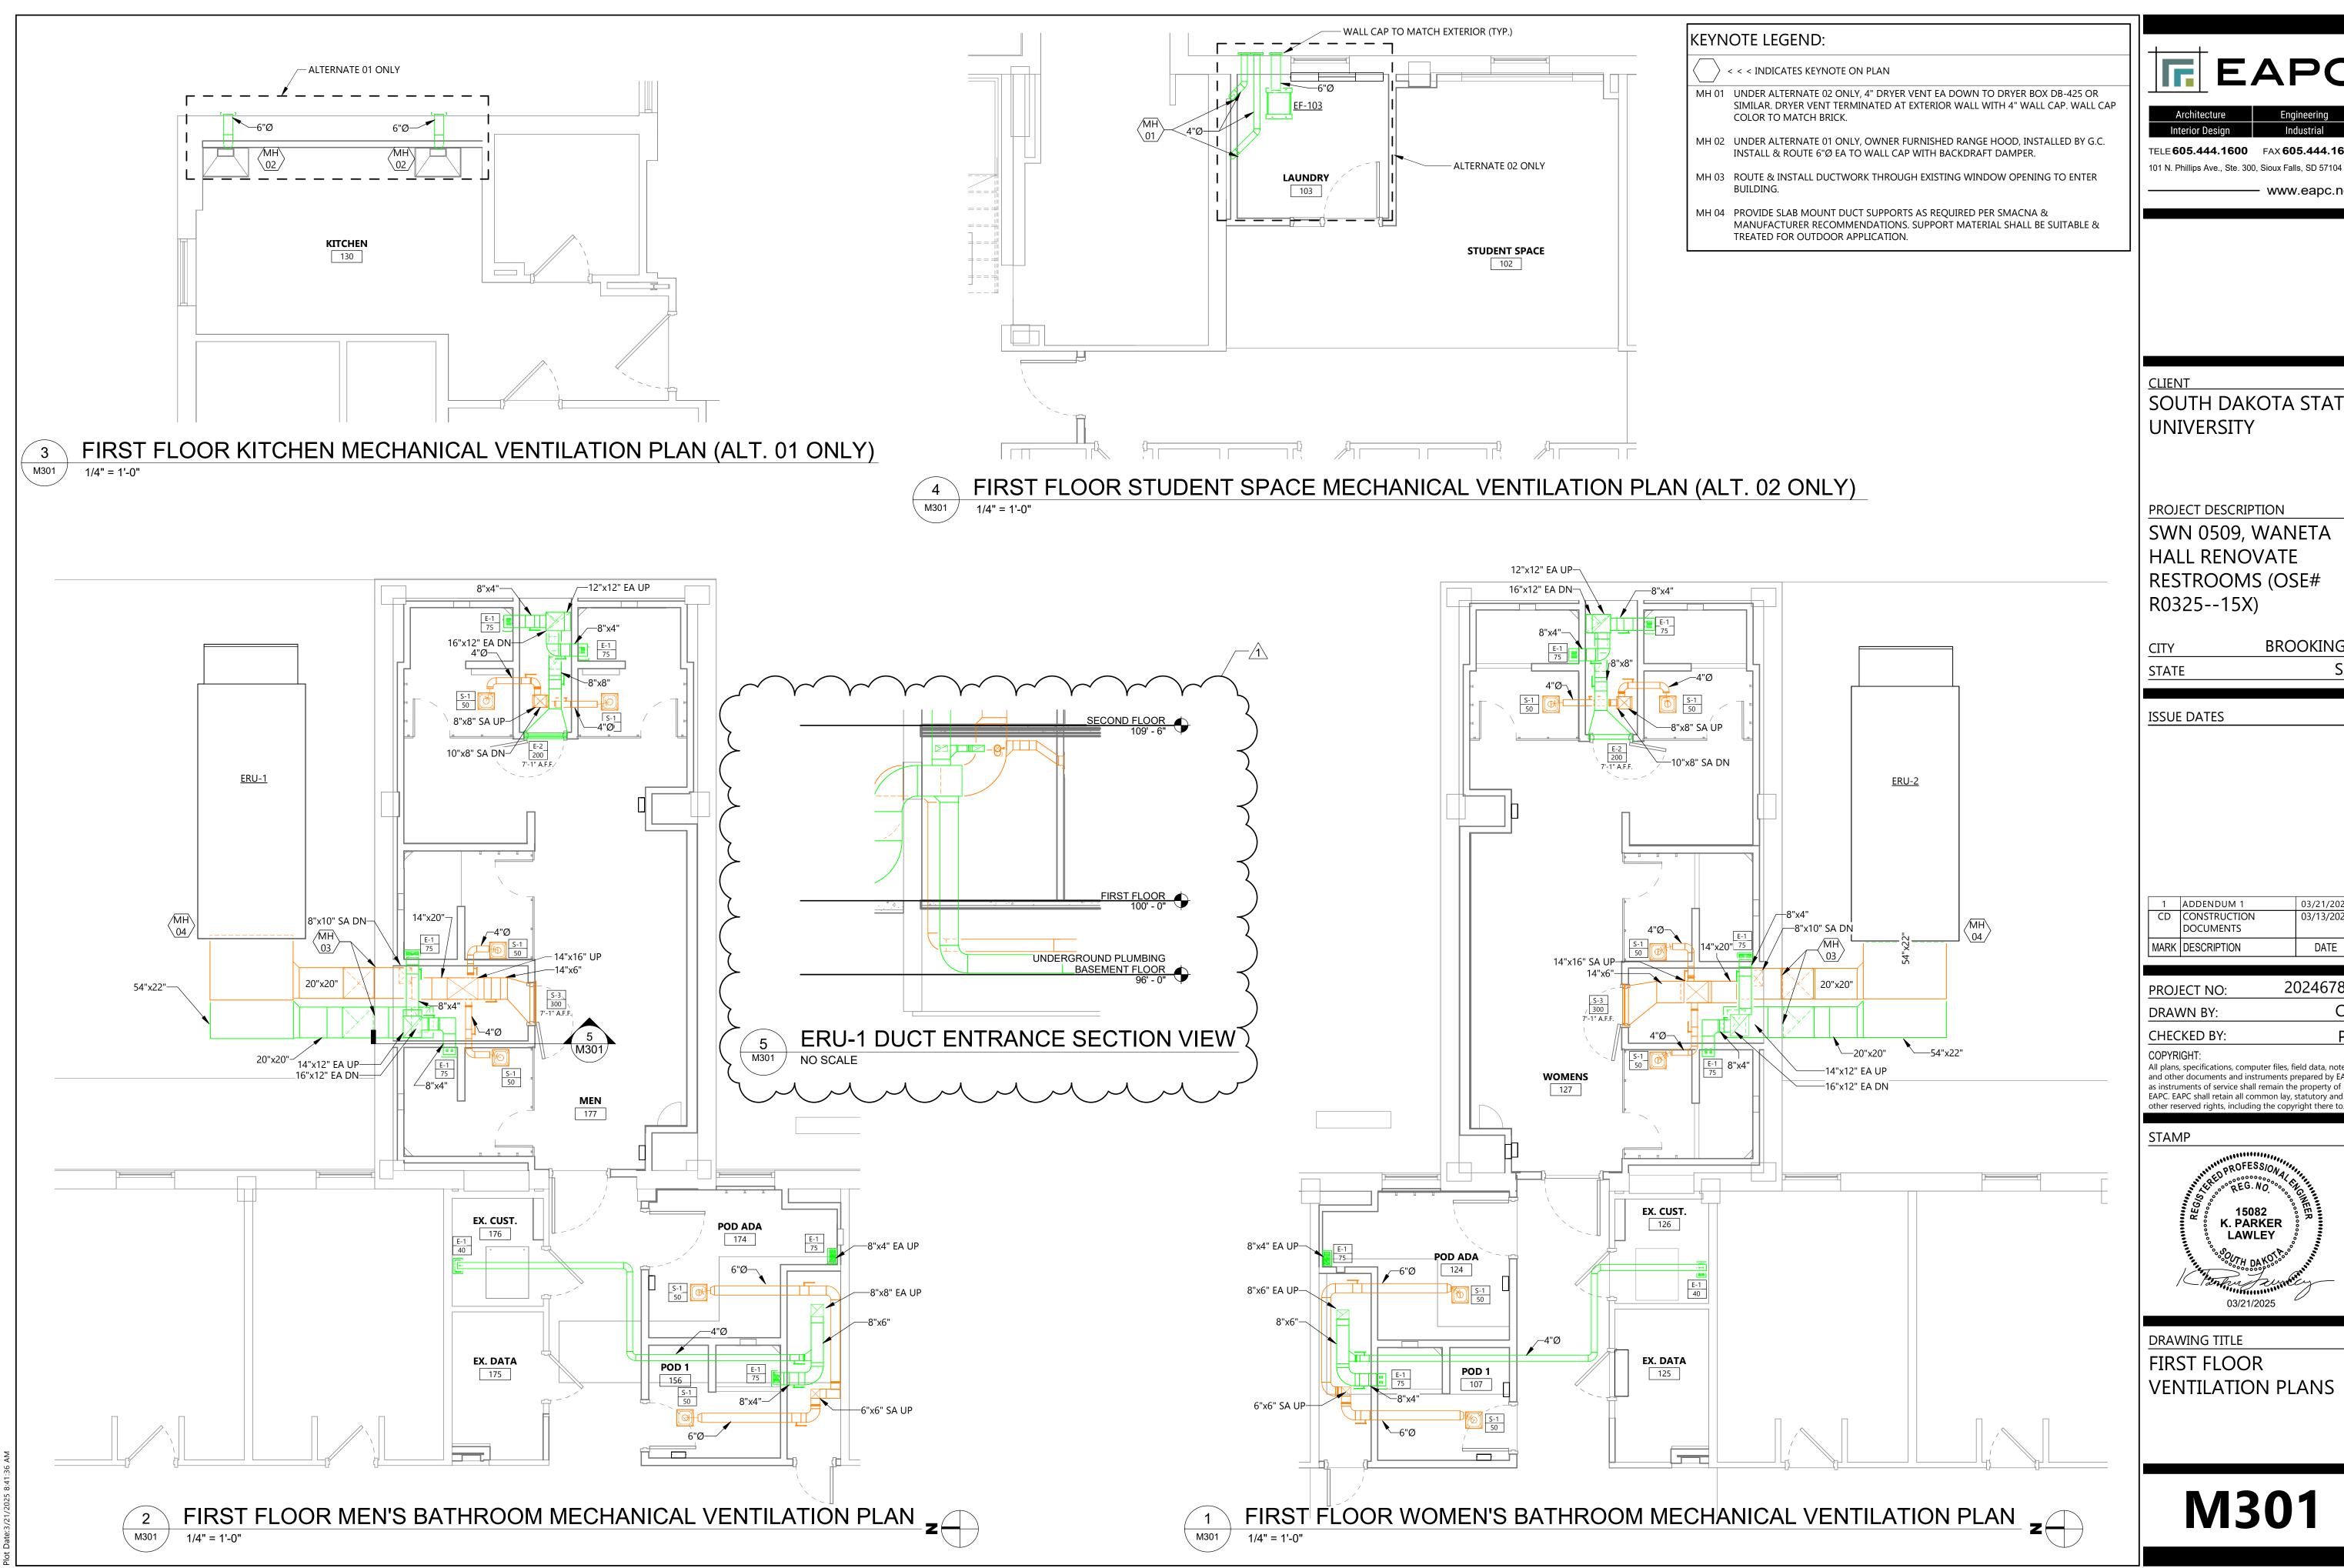177



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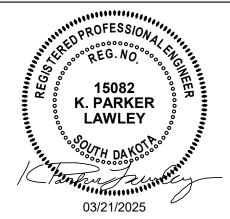
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DRAWING TITLE FIRST FLOOR VENTILATION PLANS

M301

Ø 12. *M* 5

FIRST FLOOR DEMOLITION PLAN- MENS FLOOR

E101

1/4" = 1'-0"



A. WINDICATES ITEM TO BE REMOVED. DEMOLITION SHOWN ON THE DRAWING SHALL BE INTENDED ONLY AS A GUIDE. IT SHALL BE THE RESPONSIBILITY OF THE CONTRACTOR TO VISIT & FAMILIARIZE THEMSELF WITH THE SITE PRIOR TO BIDDING THEREIN TO DETERMINE THE AMOUNT OF WORK OF DEMOLITION REQUIRED. NO EXTRA COMPENSATION TO BE ALLOWED DUE TO MISUNDERSTANDING AS TO THE AMOUNT OF WORK INVOLVED DUE TO OF THEIR LACK OF KNOWLEDGE OF ANY EXISTING CONDITIONS.

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KEYNOTE LEGEND:

< < < INDICATES KEYNOTE ON PLAN</p>

- 1. FIRE ALARM DEVICE SHALL BE REMOVED, CLEANED AND STORED FOR INSTALLATION IN NEW CEILING MAINTAIN AND PULL CABLING BACK TO ACCESSIBLE CEILING SPACE FOR INSTALLATION IN NEW CEILING.
- 2. DISCONNECT HAND DRYER AND TURN OVER TO OWNER. REMOVE CONDUIT AND WIRE BACK TO SOURCE.
- CEILING IN CORRIDOR TO BE REMOVED TO DOTTED LINE. REMOVE AND SUPPORT ALL CEILING MOUNTED DEVICES. SUPPORT CABLING ABOVE CEILING AS NEEDED. NOT ALL DEVICES SHOWN.
- 4. SURFACE RACEWAY SHALL BE DISCONNECTED, CLEANED, AND TURNED OVER TO OWNER. DISPOSE OF SURFACE RACEWAY IF REFUSED BY OWNER.
- 5. CIRCUIT FOR RECEPTACLE SHALL BE CONNECTED TO NEW CIRCUIT IN ROOM.

CLIENT

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PROJECT DESCRIPTION

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STATE	SD
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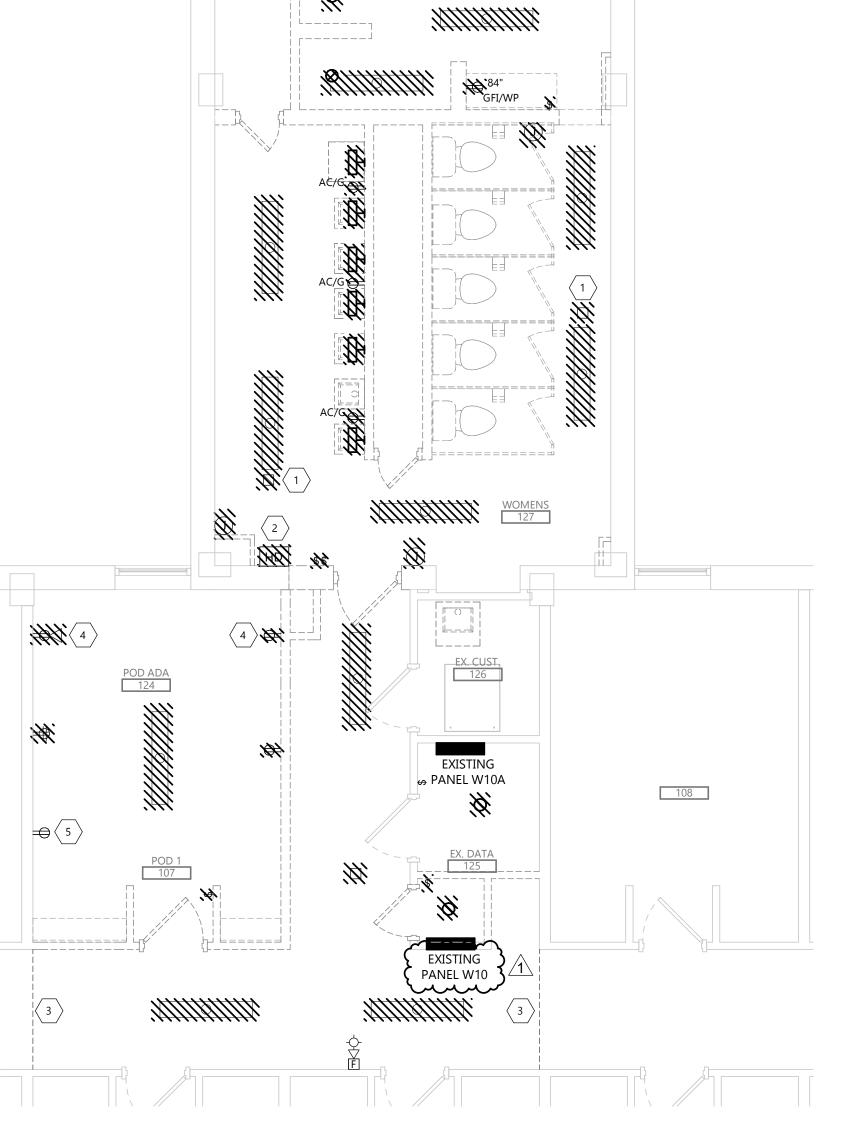
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DRAWING TITLE

FIRST FLOOR
DEMOLITION PLAN

E101



FIRST FLOOR DEMOLITION PLAN- WOMENS FLOOR

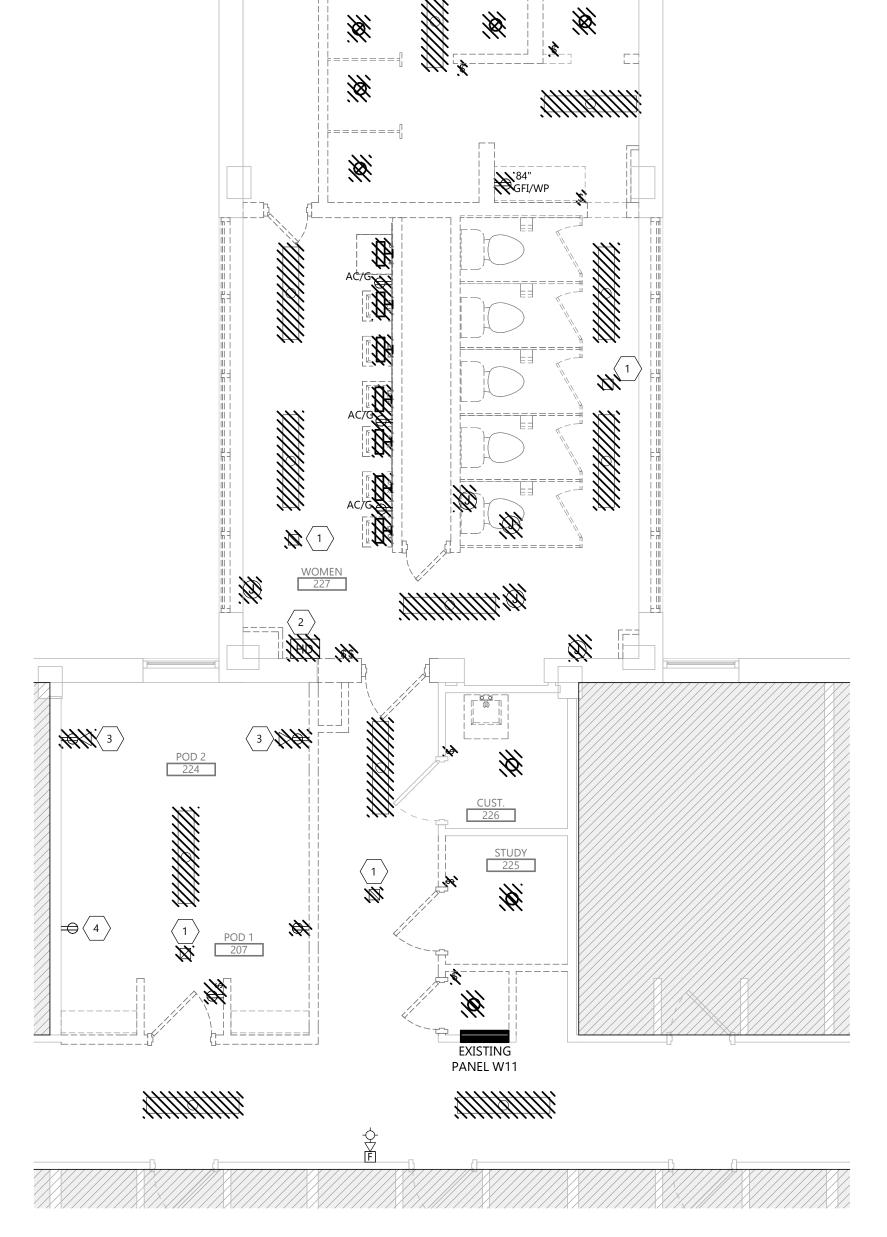
1 E101

F===== }----*\\ \\ * '\$\delta'. 84" GFI/WP 3 **////// H** (3) 257/ 4 HHHHH

SECOND FLOOR DEMOLITION PLAN-MENS

E102

1/4" = 1'-0"



GENERAL DEMO NOTES

- SHALL BE INTENDED ONLY AS A GUIDE. IT SHALL BE THE RESPONSIBILITY OF THE CONTRACTOR TO VISIT & FAMILIARIZE THEMSELF WITH THE SITE PRIOR TO BIDDING THEREIN TO DETERMINE THE AMOUNT OF WORK OF DEMOLITION REQUIRED. NO EXTRA COMPENSATION TO BE ALLOWED DUE TO MISUNDERSTANDING AS TO THE AMOUNT OF WORK INVOLVED DUE TO OF THEIR LACK OF KNOWLEDGE OF ANY EXISTING CONDITIONS.
- B. RECONNECT ANY LIGHTING OR POWER CIRCUIT INADVERTENTLY DISCONNECTED BY DEMOLITION.
- C. EXISTING SECURITY SYSTEM SHALL REMAIN IN PLACE. MAINTAIN ALL EXISTING DEVICES AND CIRCUITRY.
- D. AFTER DEMOLITION, EC SHALL DETERMINE THE NUMBER OF CIRCUITS AVAILABLE AND CONSULT WITH ENGINEER TO REVISE CIRCUITRY AS REQUIRED.

KEYNOTE LEGEND:

< < INDICATES KEYNOTE ON PLAN
</p>

- 1. FIRE ALARM DEVICE SHALL BE REMOVED, CLEANED AND STORED FOR INSTALLATION IN NEW CEILING MAINTAIN AND PULL CABLING BACK TO ACCESSIBLE CEILING SPACE FOR INSTALLATION IN NEW CEILING.
- DISCONNECT HAND DRYER AND TURN OVER TO OWNER. REMOVE CONDUIT AND WIRE BACK TO SOURCE.
- 3. SURFACE RACEWAY SHALL BE DISCONNECTED, CLEANED, AND TURNED OVER TO OWNER. DISPOSE OF SURFACE RACEWAY IF REFUSED BY OWNER.
- 4. CIRCUIT FOR RECEPTACLE SHALL BE CONNECTED TO NEW CIRCUIT IN ROOM.

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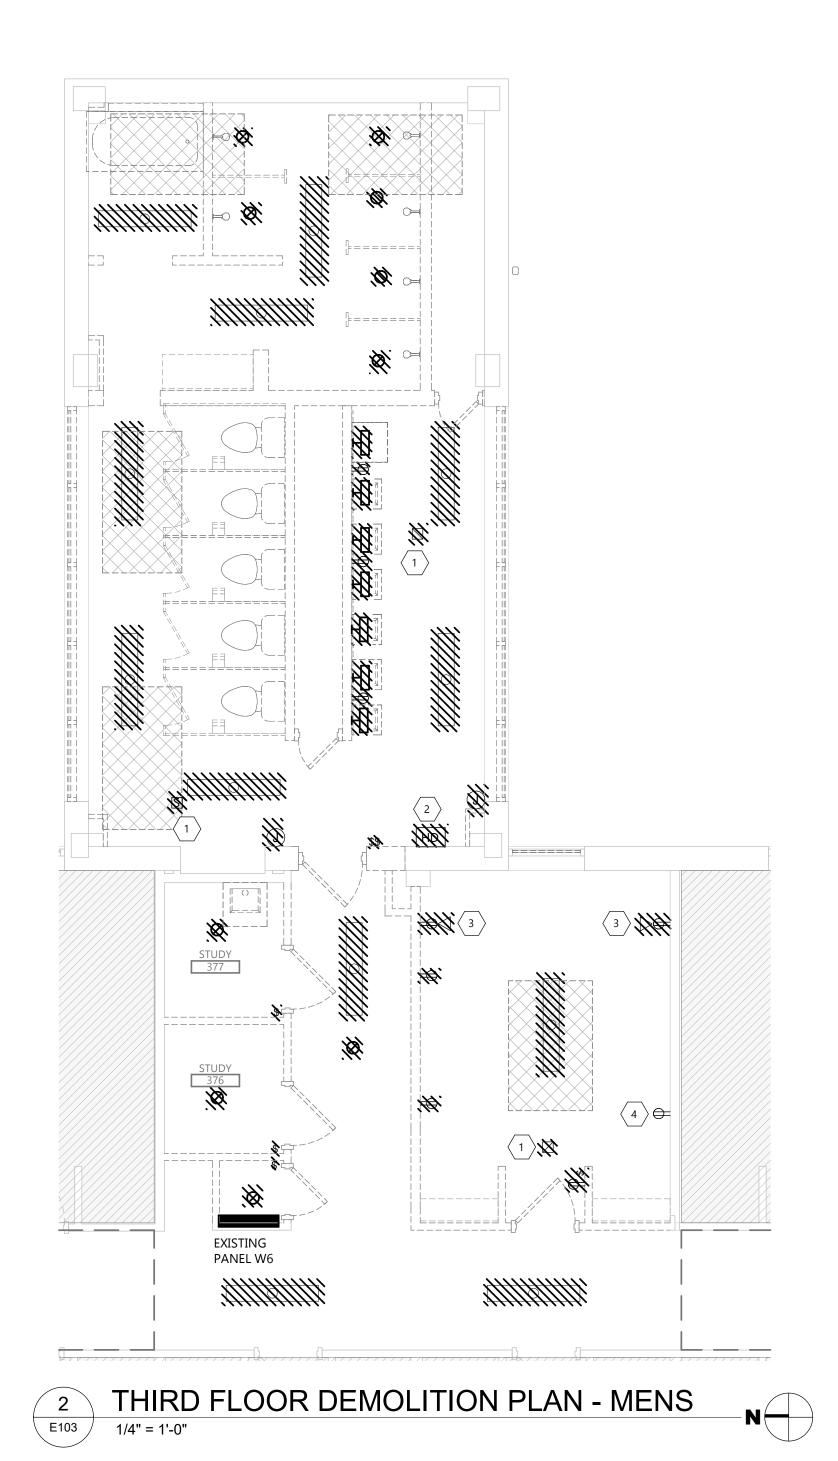



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SECOND FLOOR **DEMOLITION PLAN**

E102

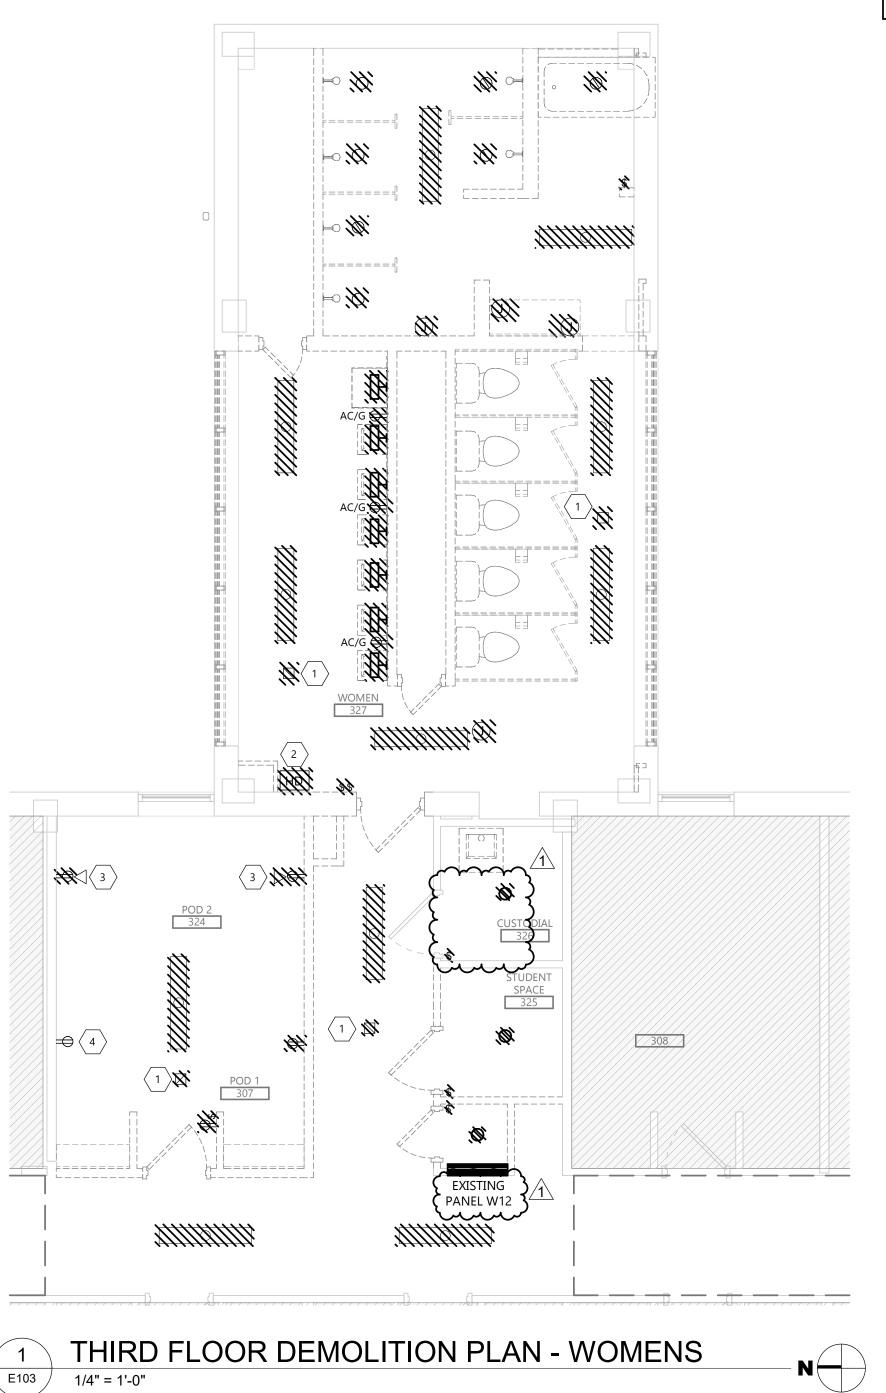SECOND FLOOR DEMOLITION PLAN- WOMENS





E103

1/4" = 1'-0"

GENERAL DEMO NOTES

- SHALL BE INTENDED ONLY AS A GUIDE. IT SHALL BE THE RESPONSIBILITY OF THE CONTRACTOR TO VISIT & FAMILIARIZE THEMSELF WITH THE SITE PRIOR TO BIDDING THEREIN TO DETERMINE THE AMOUNT OF WORK OF DEMOLITION REQUIRED. NO EXTRA COMPENSATION TO BE ALLOWED DUE TO MISUNDERSTANDING AS TO THE AMOUNT OF WORK INVOLVED DUE TO OF THEIR LACK OF KNOWLEDGE OF ANY EXISTING CONDITIONS.
- RECONNECT ANY LIGHTING OR POWER CIRCUIT INADVERTENTLY DISCONNECTED BY DEMOLITION.
 - EXISTING SECURITY SYSTEM SHALL REMAIN IN PLACE. MAINTAIN ALL EXISTING DEVICES AND CIRCUITRY.
- D. AFTER DEMOLITION, EC SHALL DETERMINE THE NUMBER OF CIRCUITS AVAILABLE AND CONSULT WITH ENGINEER TO REVISE CIRCUITRY AS REQUIRED.

KEYNOTE LEGEND:



< < < INDICATES KEYNOTE ON PLAN</p>

- FIRE ALARM DEVICE SHALL BE REMOVED, CLEANED AND STORED FOR INSTALLATION IN NEW CEILING MAINTAIN AND PULL CABLING BACK TO ACCESSIBLE CEILING SPACE FOR INSTALLATION IN NEW CEILING.
- DISCONNECT HAND DRYER AND TURN OVER TO OWNER. REMOVE CONDUIT AND WIRE BACK TO SOURCE.
- SURFACE RACEWAY SHALL BE DISCONNECTED, CLEANED, AND TURNED OVER TO OWNER. DISPOSE OF SURFACE RACEWAY IF REFUSED BY OWNER.
- 4. CIRCUIT FOR RECEPTACLE SHALL BE CONNECTED TO NEW CIRCUIT IN ROOM.



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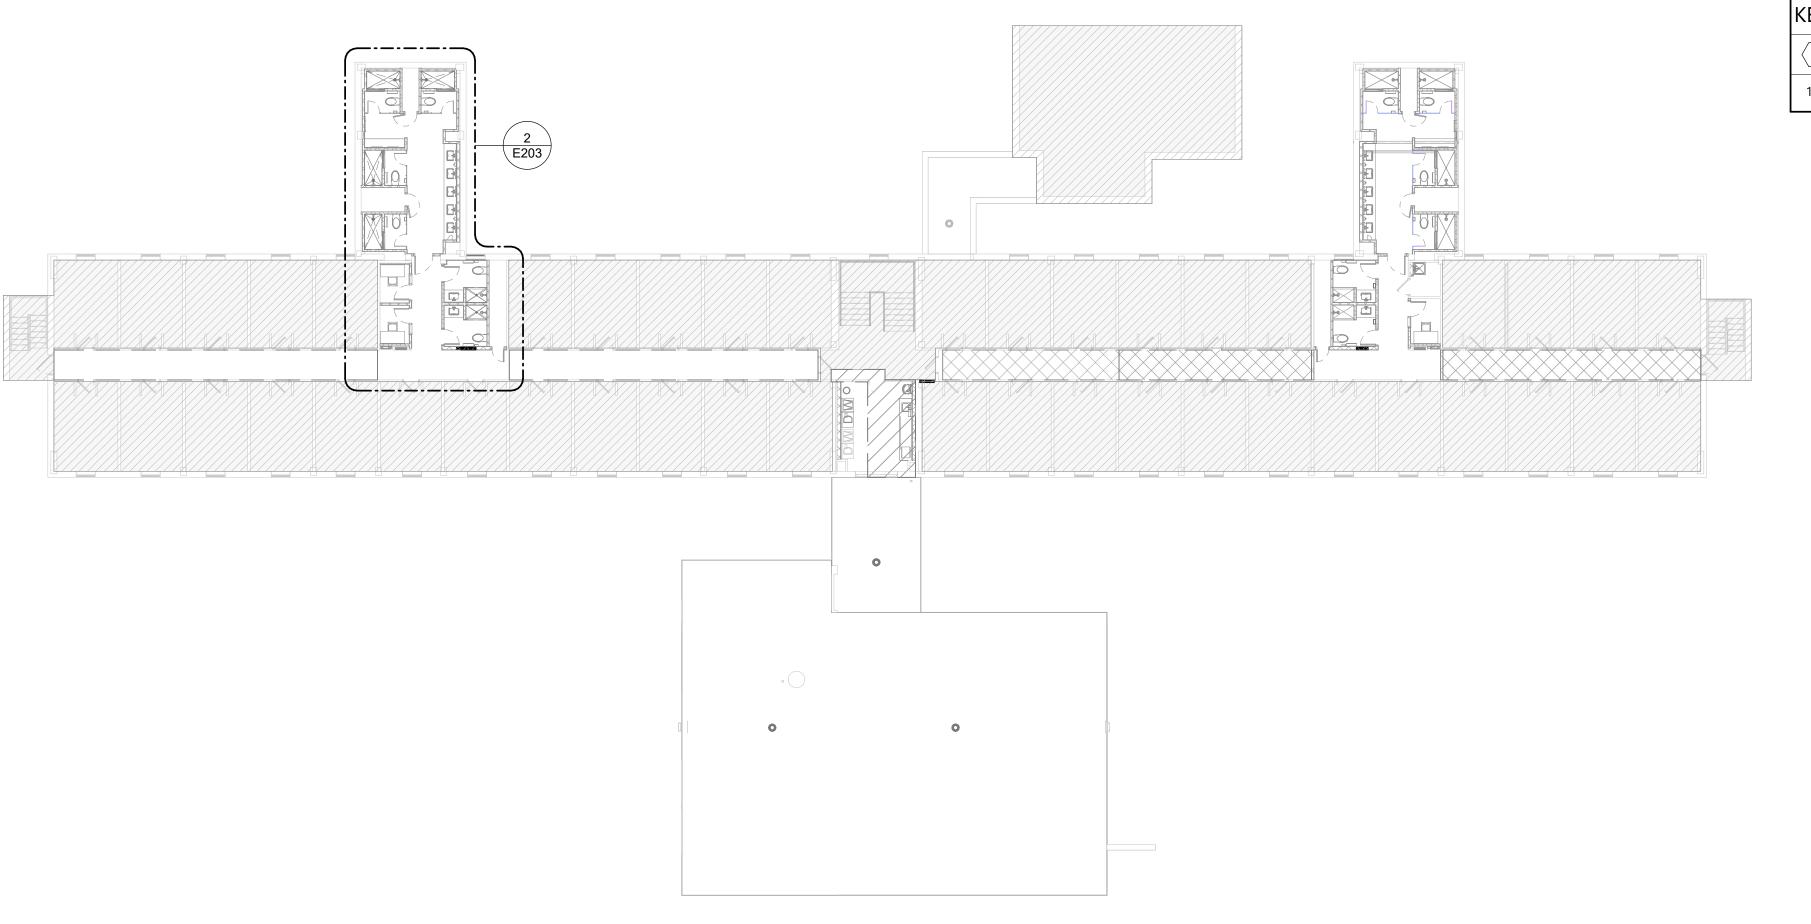
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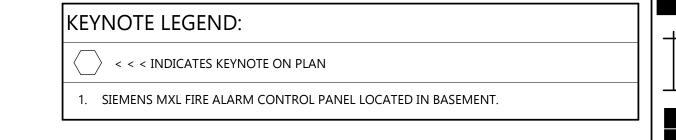


DRAWING TITLE

THIRD FLOOR **DEMOLITION PLAN**

E103





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HALL RENOVATE

RESTROOM (OSE#

R0325--15X)

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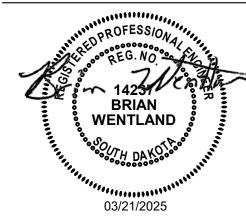
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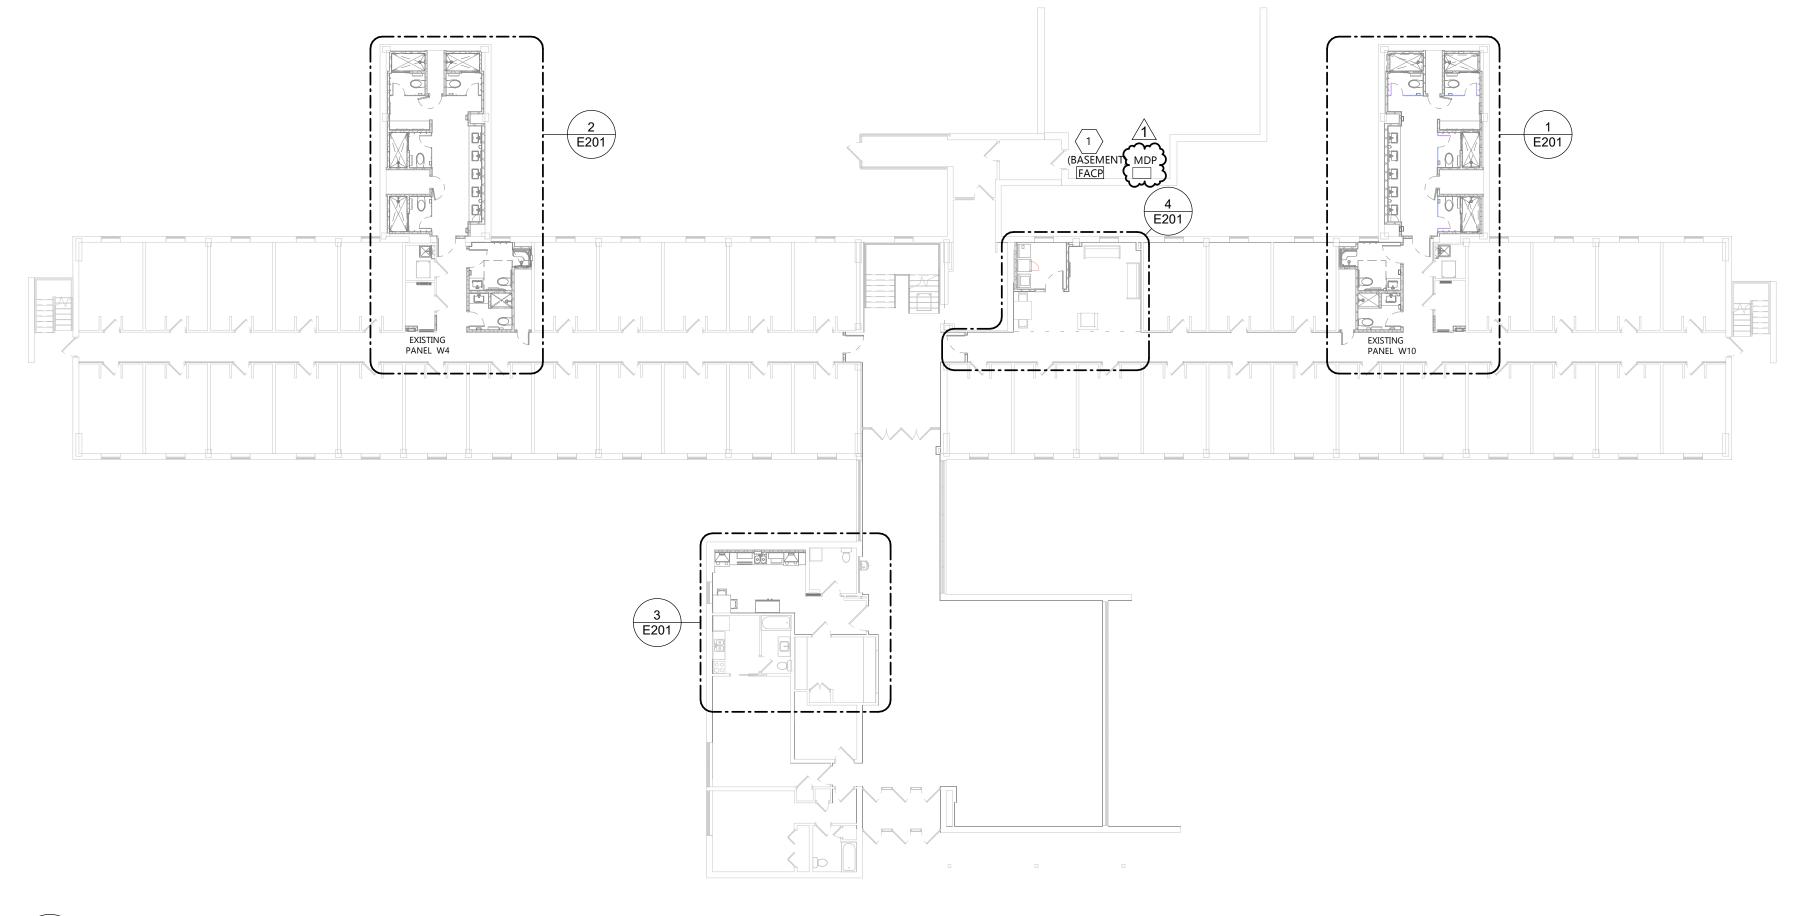
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OVERALL PLANS


E200



OVERALL PLAN - SECOND / THIRD FLOORS

E200

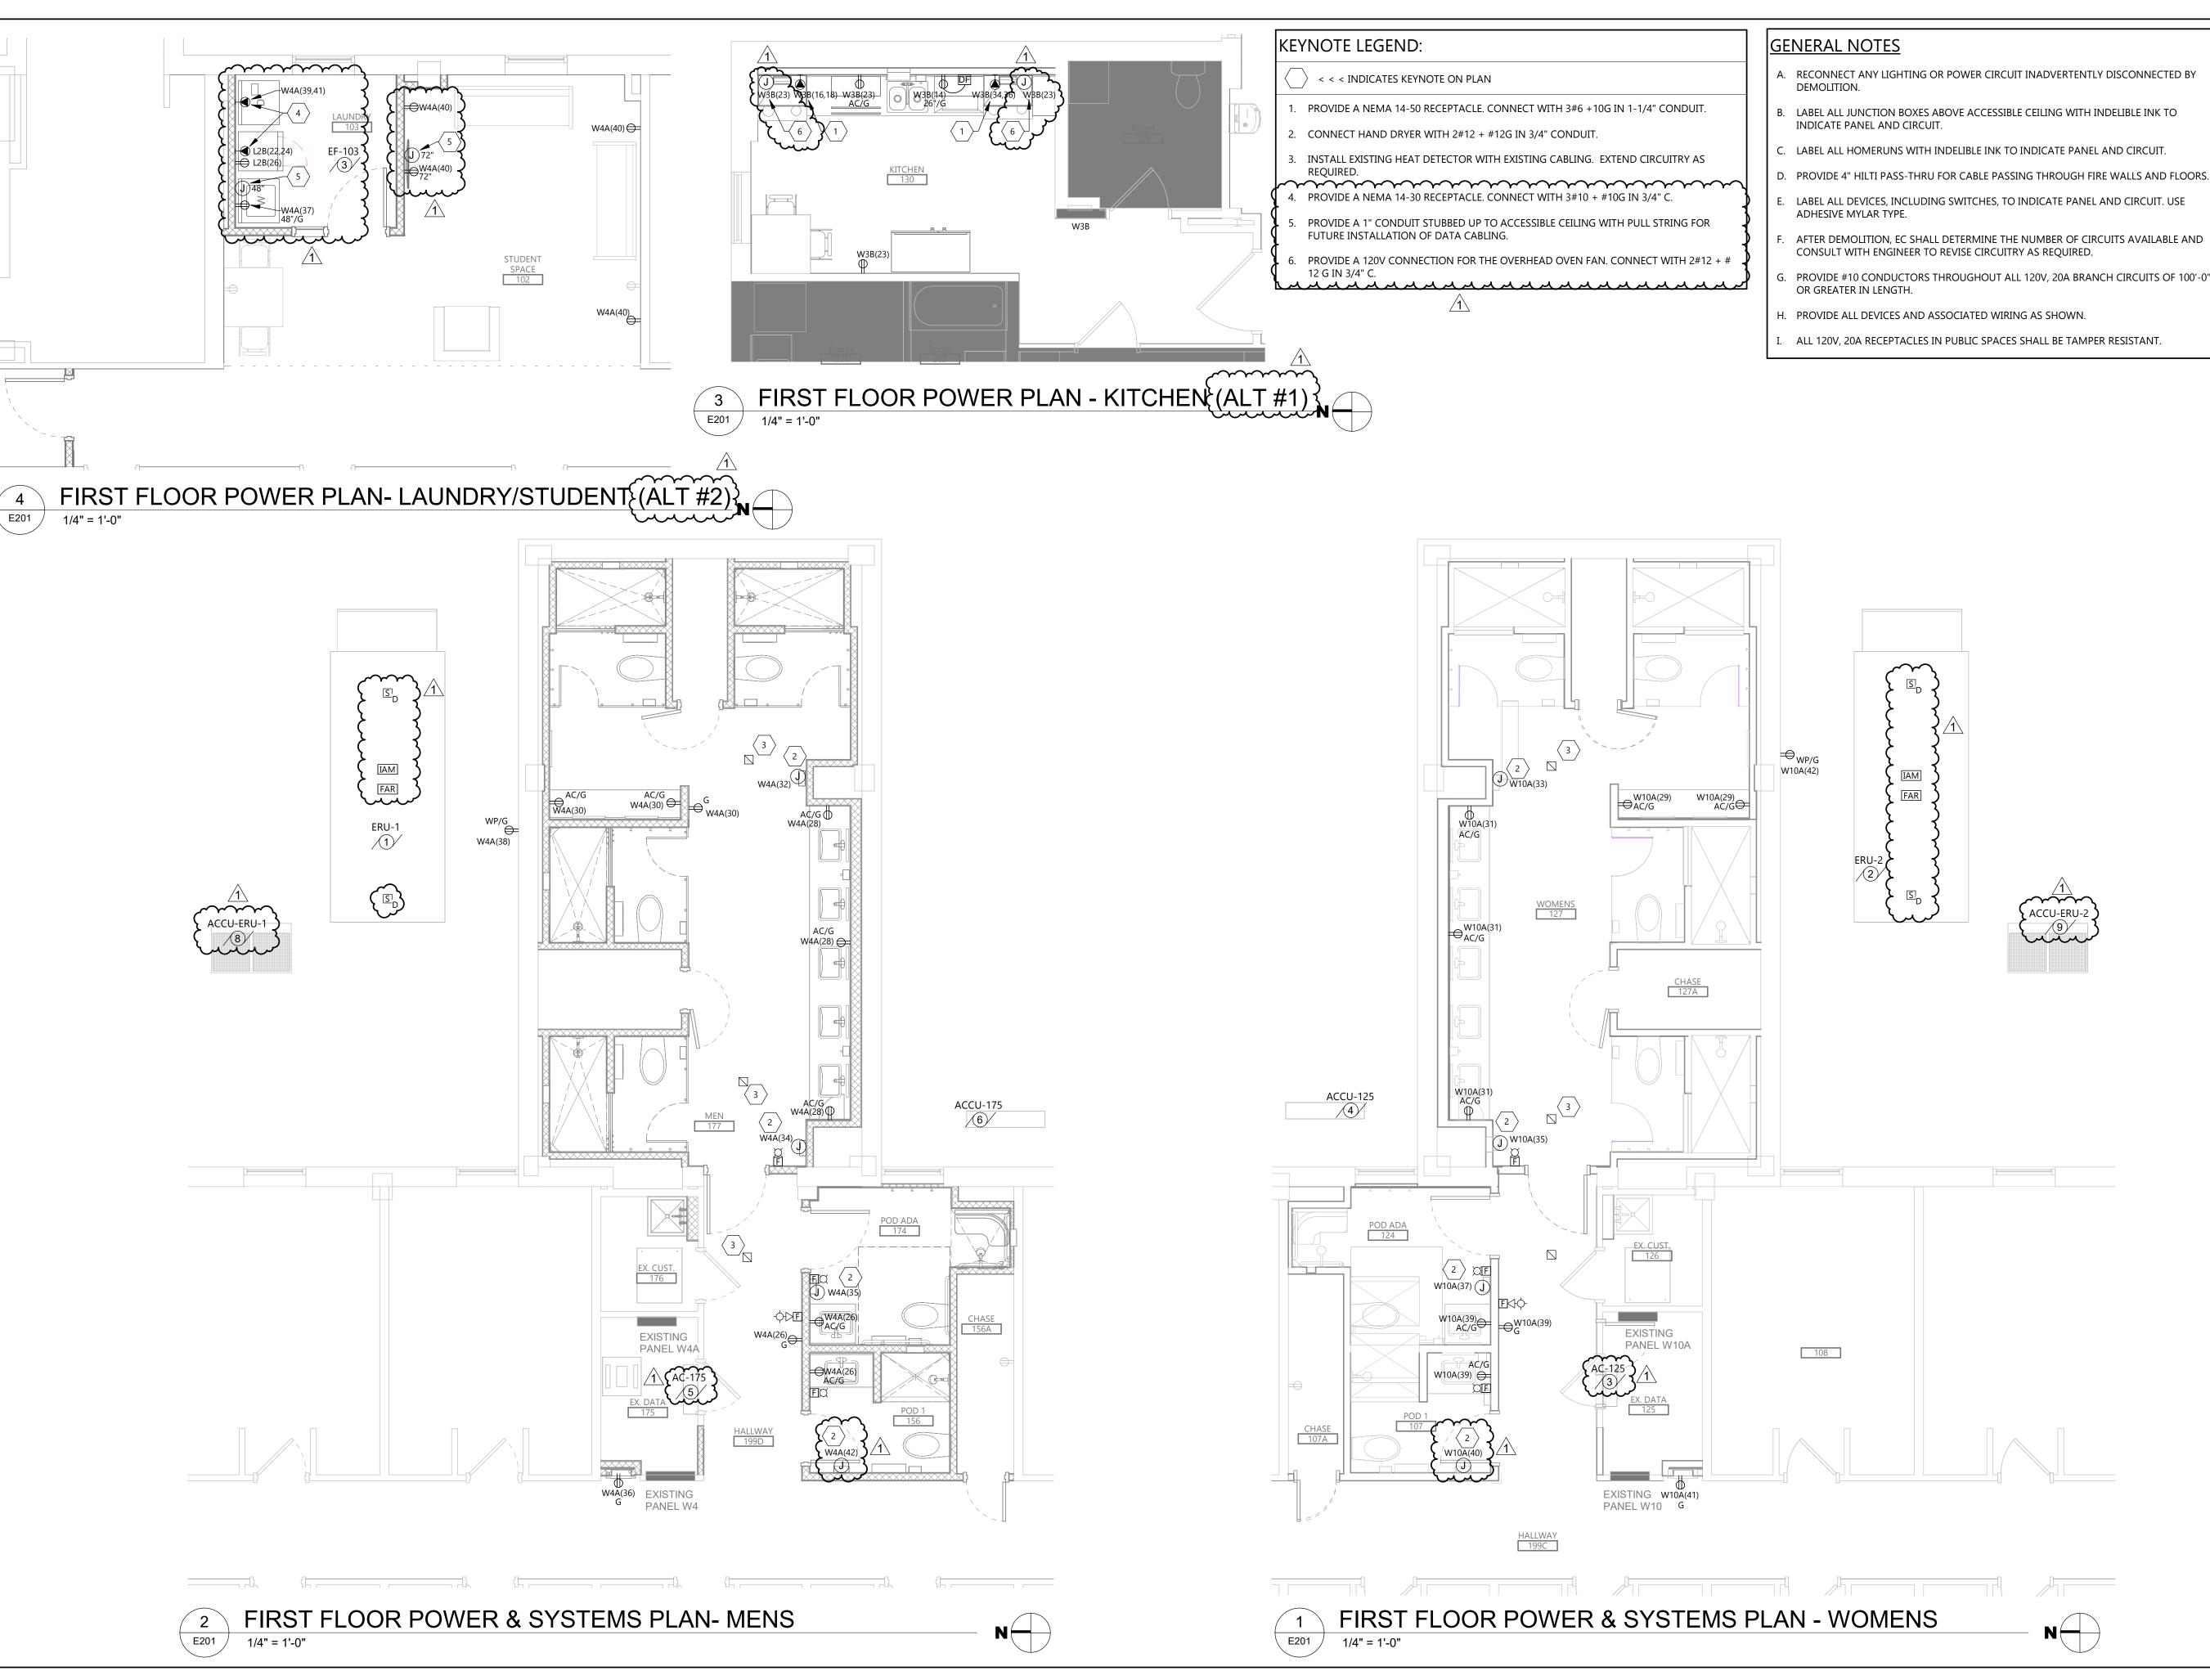1/16" = 1'-0"



A. RECONNECT ANY LIGHTING OR POWER CIRCUIT INADVERTENTLY DISCONNECTED BY

E. LABEL ALL DEVICES, INCLUDING SWITCHES, TO INDICATE PANEL AND CIRCUIT. USE

PROVIDE #10 CONDUCTORS THROUGHOUT ALL 120V, 20A BRANCH CIRCUITS OF 100'-0"

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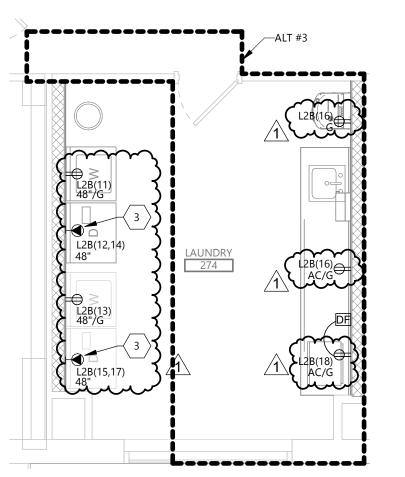
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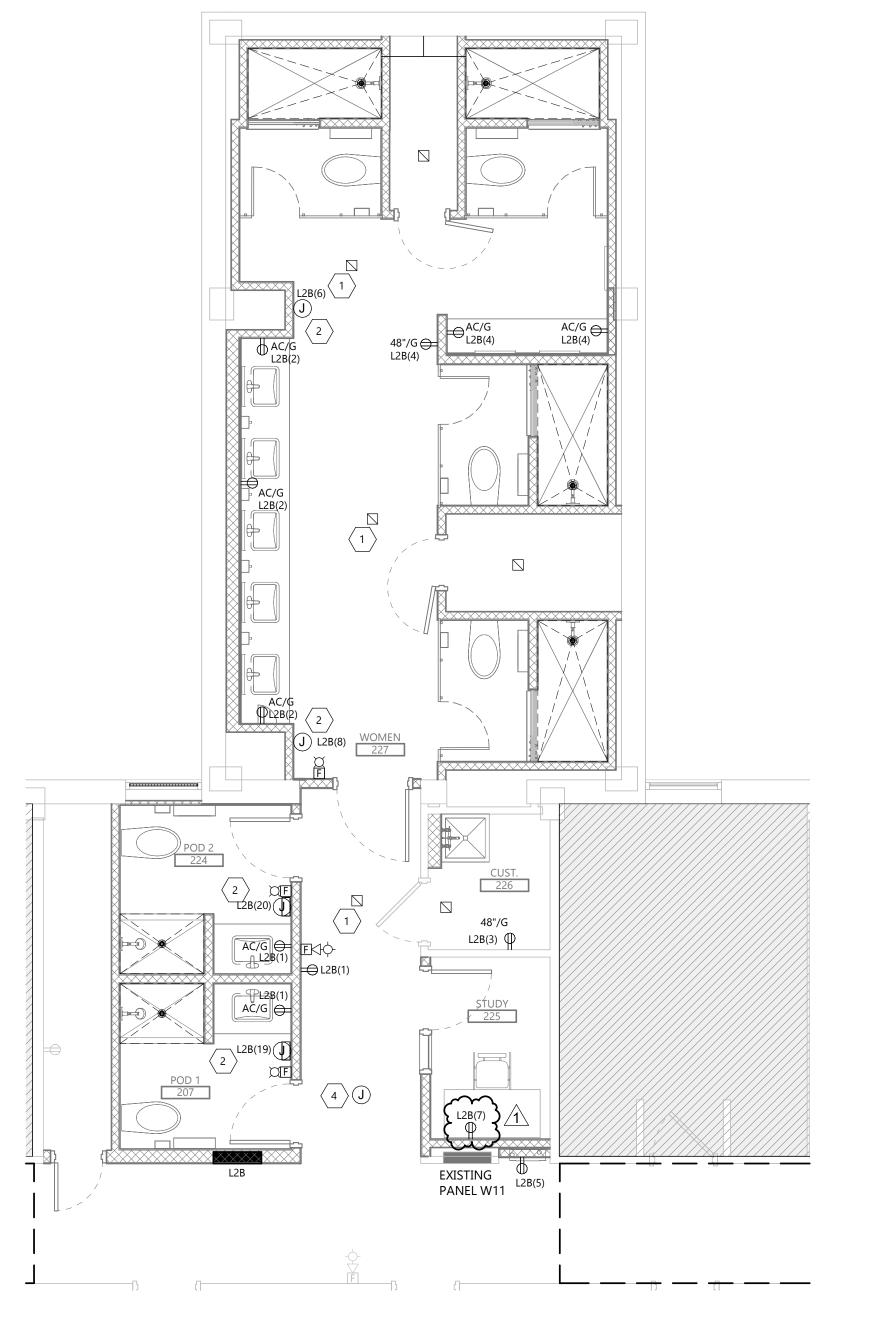
DRAWING TITLE

FIRST FLOOR POWER & SYSTEMS PLAN

E201



SECOND FLOOR LAUNDRY PLAN (ALT #3) E202 1/4" = 1'-0"



GENERAL NOTES

- A. RECONNECT ANY LIGHTING OR POWER CIRCUIT INADVERTENTLY DISCONNECTED BY DEMOLITION.
- B. LABEL ALL JUNCTION BOXES ABOVE ACCESSIBLE CEILING WITH INDELIBLE INK TO INDICATE PANEL AND CIRCUIT.
- C. LABEL ALL HOMERUNS WITH INDELIBLE INK TO INDICATE PANEL AND CIRCUIT.
- D. PROVIDE 4" HILTI PASS-THRU FOR CABLE PASSING THROUGH FIRE WALLS AND FLOORS.
- E. LABEL ALL DEVICES, INCLUDING SWITCHES, TO INDICATE PANEL AND CIRCUIT. USE ADHESIVE MYLAR TYPE.
- AFTER DEMOLITION, EC SHALL DETERMINE THE NUMBER OF CIRCUITS AVAILABLE AND CONSULT WITH ENGINEER TO REVISE CIRCUITRY AS REQUIRED.
- 6. PROVIDE #10 CONDUCTORS THROUGHOUT ALL 120V, 20A BRANCH CIRCUITS OF 100'-0" OR GREATER IN LENGTH.
- H. PROVIDE ALL DEVICES AND ASSOCIATED WIRING AS SHOWN.
- ALL 120V, 20A RECEPTACLES IN PUBLIC SPACES SHALL BE TAMPER RESISTANT.

KEYNOTE LEGEND:

< < INDICATES KEYNOTE ON PLAN
</p>

INSTALL EXISTING HEAT DETECTOR WITH EXISTING CABLING. EXTEND CIRCUITRY AS

CONNECT HAND DRYER WITH 2 #12 + #12G IN 3/4" C.

 \cdots 3. PROVIDE A NEMA 14-30 RECEPTACLE. CONNECT WITH 3#10 + #10G IN 3/4" C.

PROVIDE A JUNCTION BOX IN CEILING FOR INSTALLATION OF FUTURE WIRELESS ACCESS POINT BY OWNER. STUB 3/4" CONDUIT FROM JUNCTION BOX TO ACCESSIBLE CEILING.

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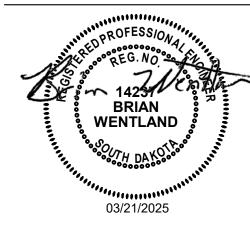
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DRAWING TITLE

SECOND FLOOR POWER & SYSTEMS PLAN

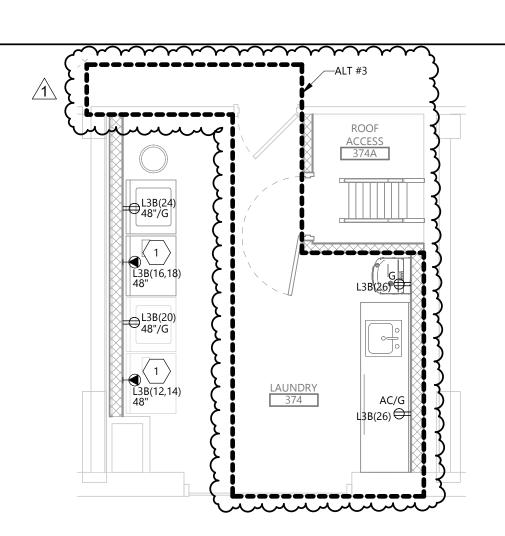
E202

SECOND FLOOR POWER & SYSTEMS PLAN- MENS E202

E202

SECOND FLOOR POWER & SYSTEMS PLAN - WOMENS

1/4" = 1'-0"



THIRD FLOOR LAUNDRY POWER PLAN (ALT #3)

1/4" = 1'-0" 3 E203

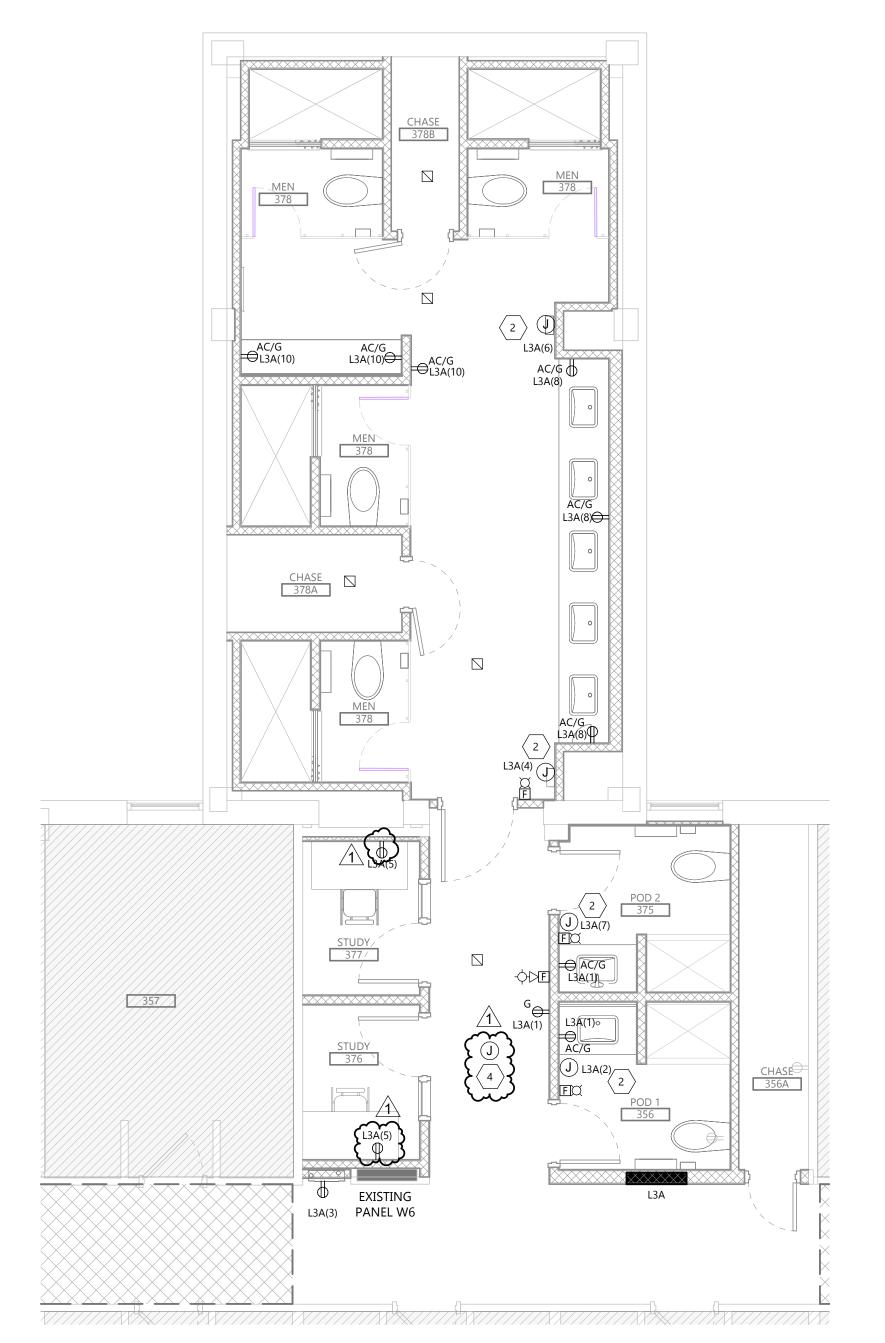


AC/G L3B(9) ⊖

L3B(4)

EXISTING \oplus

PANEL W12 L3B(5)







GENERAL NOTES

- A. RECONNECT ANY LIGHTING OR POWER CIRCUIT INADVERTENTLY DISCONNECTED BY DEMOLITION.
- B. LABEL ALL JUNCTION BOXES ABOVE ACCESSIBLE CEILING WITH INDELIBLE INK TO INDICATE PANEL AND CIRCUIT.
- C. LABEL ALL HOMERUNS WITH INDELIBLE INK TO INDICATE PANEL AND CIRCUIT.
- D. PROVIDE 4" HILTI PASS-THRU FOR CABLE PASSING THROUGH FIRE WALLS AND FLOORS.
- E. LABEL ALL DEVICES, INCLUDING SWITCHES, TO INDICATE PANEL AND CIRCUIT. USE ADHESIVE MYLAR TYPE.
- AFTER DEMOLITION, EC SHALL DETERMINE THE NUMBER OF CIRCUITS AVAILABLE AND CONSULT WITH ENGINEER TO REVISE CIRCUITRY AS REQUIRED.
- . PROVIDE #10 CONDUCTORS THROUGHOUT ALL 120V, 20A BRANCH CIRCUITS OF 100'-0" OR GREATER IN LENGTH.
- H. PROVIDE ALL DEVICES AND ASSOCIATED WIRING AS SHOWN.
- ALL 120V, 20A RECEPTACLES IN PUBLIC SPACES SHALL BE TAMPER RESISTANT.

KEYNOTE LEGEND:

< < INDICATES KEYNOTE ON PLAN
</p>

- PROVIDE A NEMA 14-30 RECEPTACLE. CONNECT WITH 3#10'S AND +10G IN 1" CONDUIT.
- PROVIDE 120V CONNECTION FOR ELECTRIC HAND DRYER. CONNECT WITH 2#12 + 12G IN 3/4" CONDUIT.
- INSTALL EXISTING HEAT DETECTOR WITH EXISTING CABLING. EXTEND CIRCUITRY AS

PROVIDE A JUNCTION BOX IN CEILING FOR INSTALLATION OF FUTURE WIRELESS ACCESS POINT BY OWNER. STUB 3/4" CONDUIT FROM JUNCTION BOX TO ACCESSIBLE CEILING.



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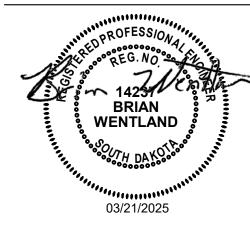
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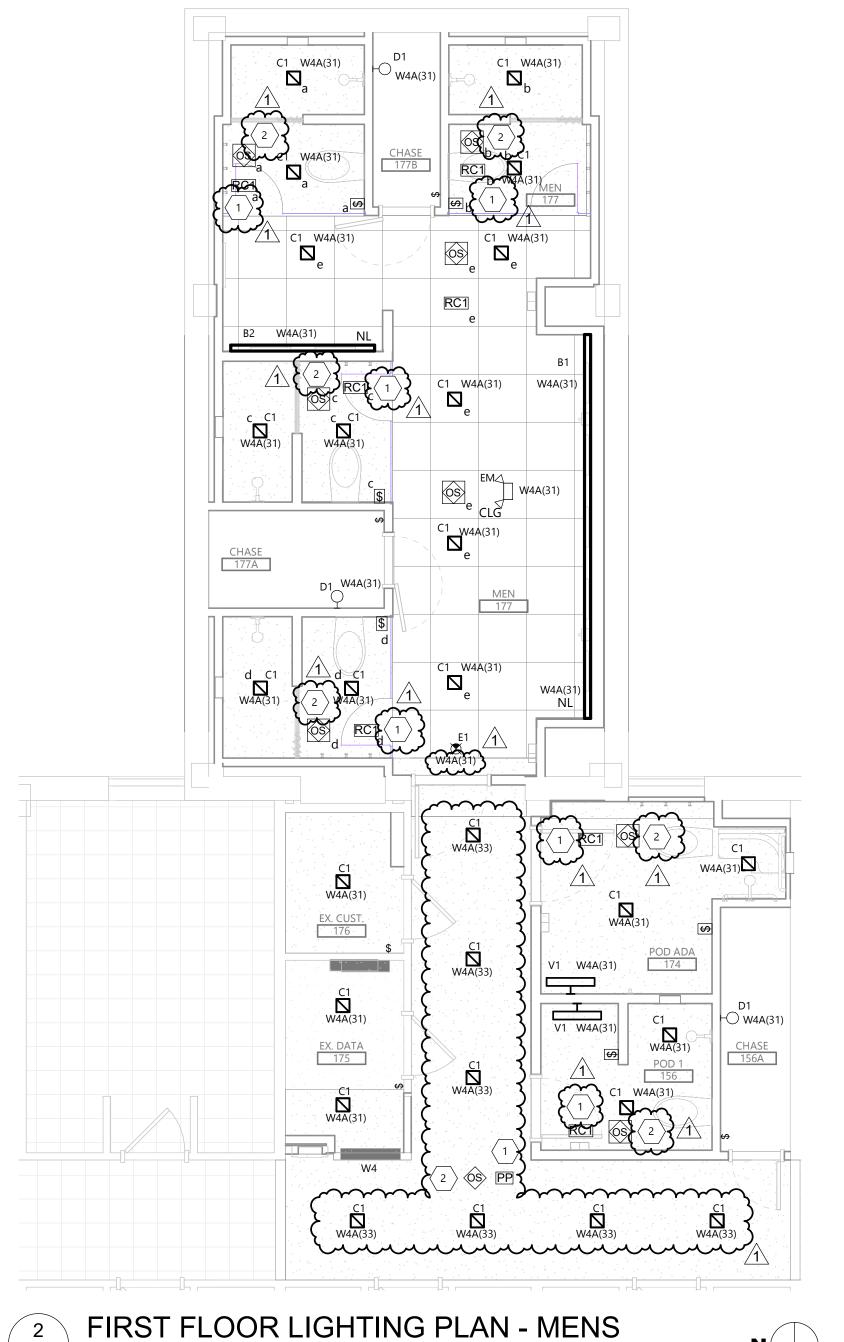
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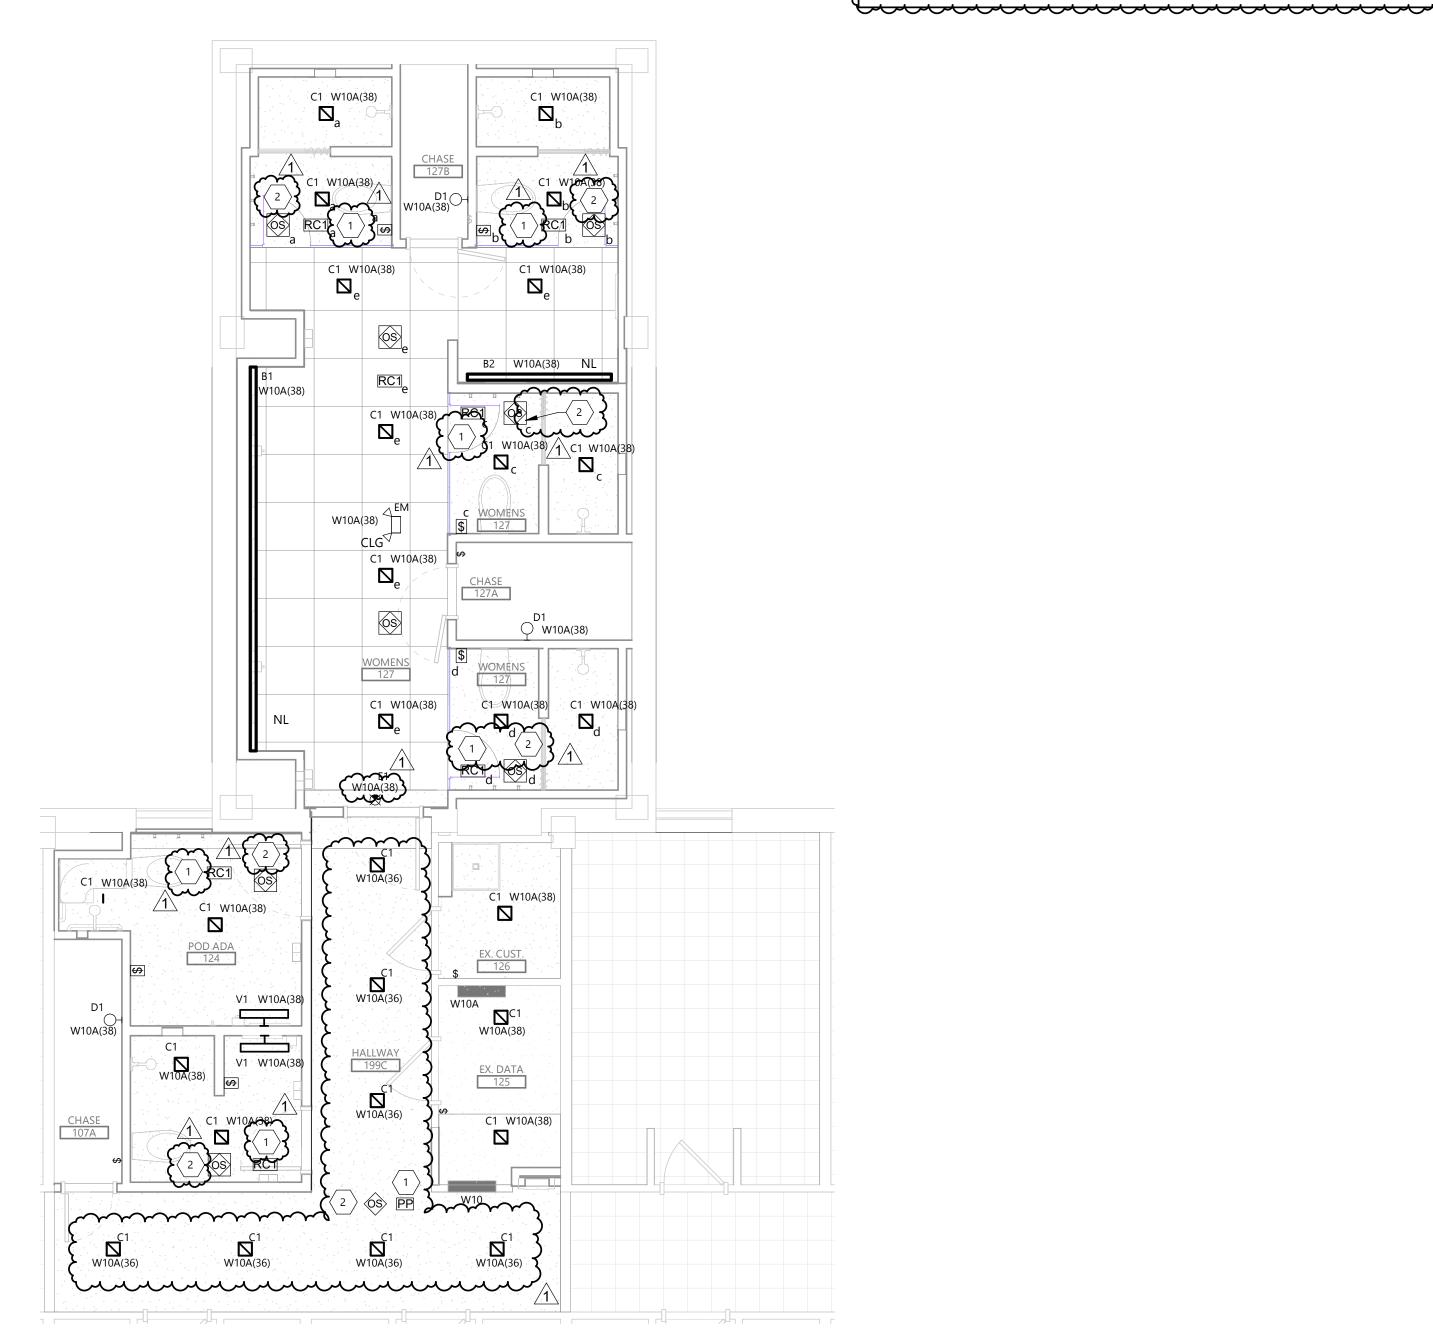


DRAWING TITLE

THIRD FLOOR POWER & SYSTEMS PLAN

E203





GENERAL NOTES

- A. RECONNECT ANY LIGHTING OR POWER CIRCUIT INADVERTENTLY DISCONNECTED BY DEMOLITION.
- B. LABEL ALL JUNCTION BOXES ABOVE ACCESSIBLE CEILING WITH INDELIBLE INK TO INDICATE PANEL AND CIRCUIT.
- C. LABEL ALL HOMERUNS WITH INDELIBLE INK TO INDICATE PANEL AND CIRCUIT.
- D. PROVIDE 4" HILTI PASS-THRU FOR CABLE PASSING THROUGH FIRE WALLS AND FLOORS.
- E. LABEL ALL DEVICES, INCLUDING SWITCHES, TO INDICATE PANEL AND CIRCUIT. USE ADHESIVE MYLAR TYPE.
 - AFTER DEMOLITION, EC SHALL DETERMINE THE NUMBER OF CIRCUITS AVAILABLE AND CONSULT WITH ENGINEER TO REVISE CIRCUITRY AS REQUIRED.
 - G. PROVIDE #10 CONDUCTORS THROUGHOUT ALL 120V, 20A BRANCH CIRCUITS OF 100'-0" OR GREATER IN LENGTH.
- H. PROVIDE ALL DEVICES AND ASSOCIATED WIRING AS SHOWN.

KEYNOTE LEGEND:

< < INDICATES KEYNOTE ON PLAN
</p>

᠊ᢆᠯᢇᢇᢇᢇᢇᢇᢇᢇᢇᢇᢇᢇ 1. POWER PACK OR ROOM CONTROLLER SHALL BE INSTALLED IN ACCESSIBLE CEILING AND LABEL WITH ROOM BEING CONTROLLED.

COORDINATE LOCATION OF SENSOR WITH CEILING WORK FOR MECHANICAL EQUIPMENT TO AVOID CONFLICT.

Architecture Engineering Interior Design

TELE 605.444.1600 FAX 605.444.1601 101 N. Phillips Ave., Ste. 300, Sioux Falls, SD 57104

www.eapc.net

SOUTH DAKOTA STATE UNIVERSITY

PROJECT DESCRIPTION

SWN 0509, WANETA HALL RENOVATE RESTROOM (OSE# R0325--15X)

CITY	BROOKINGS
STATE	SD

ISSUE DATES

1	ADDENDUM 1	03/21/2025
CD	100% CONSTRUCTION DOCUMENTS	03/13/2025
MARK	DESCRIPTION	DATE

PROJECT NO:	20246780
DRAWN BY:	PM
CHECKED BY:	BW

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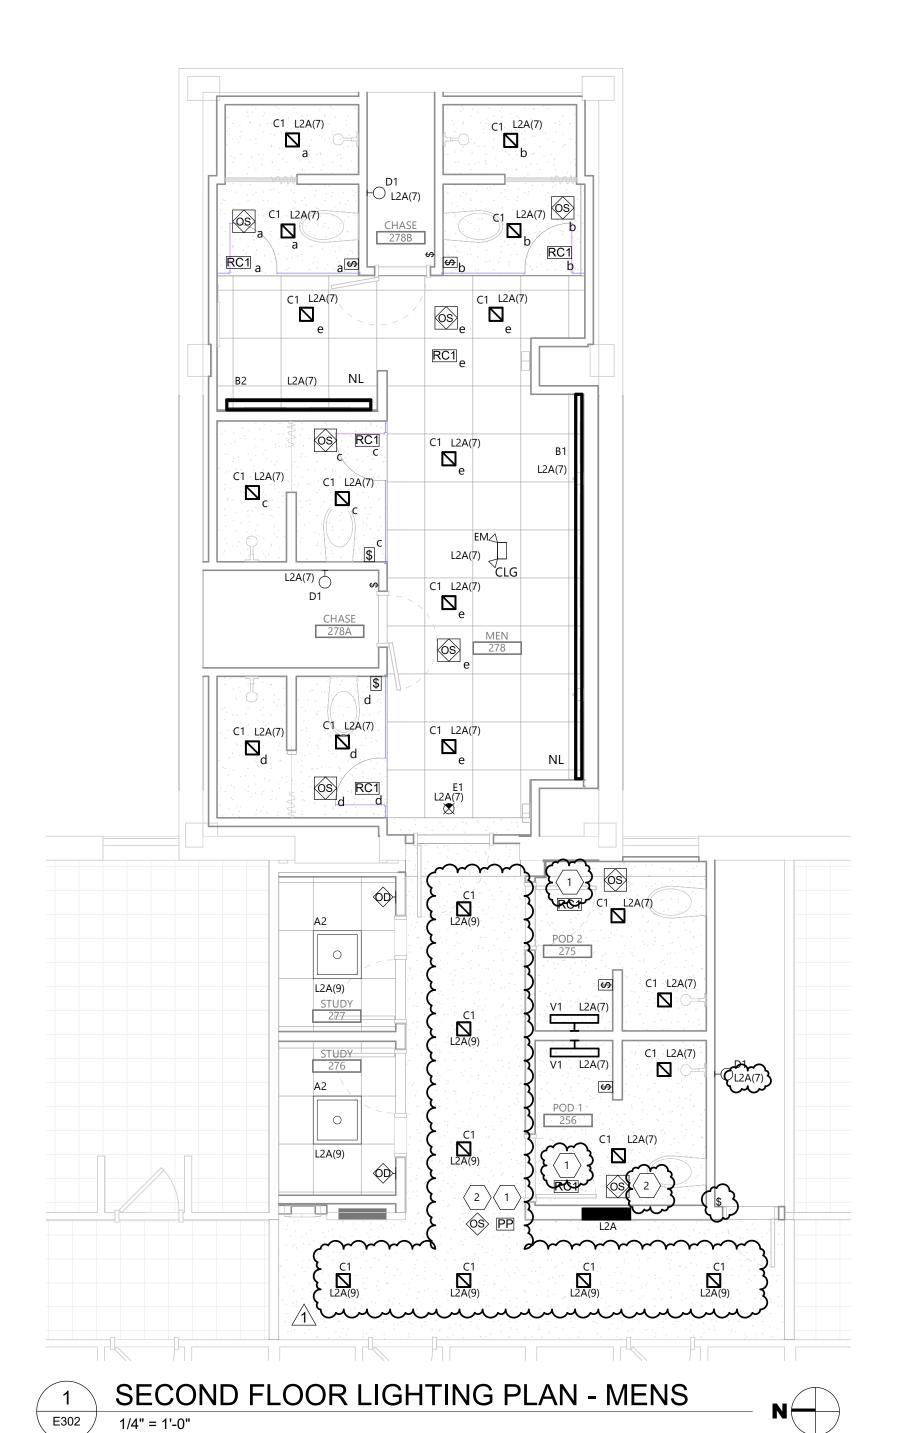
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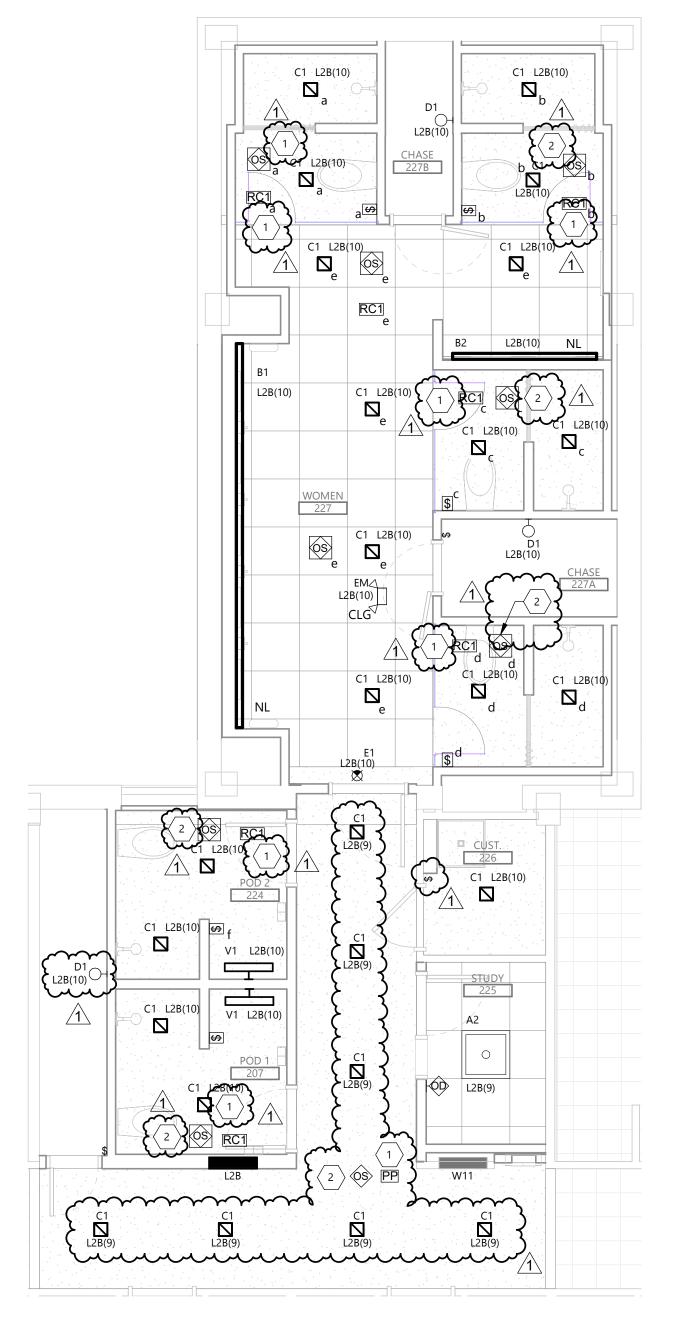
FIRST FLOOR LIGHTING PLAN

E301

E301 /

1/4" = 1'-0"





GENERAL NOTES

- A. RECONNECT ANY LIGHTING OR POWER CIRCUIT INADVERTENTLY DISCONNECTED BY DEMOLITION.
- B. LABEL ALL JUNCTION BOXES ABOVE ACCESSIBLE CEILING WITH INDELIBLE INK TO INDICATE PANEL AND CIRCUIT.
- C. LABEL ALL HOMERUNS WITH INDELIBLE INK TO INDICATE PANEL AND CIRCUIT.
- D. PROVIDE 4" HILTI PASS-THRU FOR CABLE PASSING THROUGH FIRE WALLS AND FLOORS.
- E. LABEL ALL DEVICES, INCLUDING SWITCHES, TO INDICATE PANEL AND CIRCUIT. USE ADHESIVE MYLAR TYPE.
- AFTER DEMOLITION, EC SHALL DETERMINE THE NUMBER OF CIRCUITS AVAILABLE AND CONSULT WITH ENGINEER TO REVISE CIRCUITRY AS REQUIRED.
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KEYNOTE LEGEND:

< < INDICATES KEYNOTE ON PLAN
</p>

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COORDINATE LOCATION OF SENSOR WITH CEILING WORK FOR MECHANICAL EQUIPMENT TO AVOID CONFLICT.

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DRAWING TITLE

SECOND FLOOR LIGHTING PLAN

E302


2 E302

1/4" = 1'-0"



SECOND FLOOR LIGHTING PLAN -WOMENS N

$\left| \bigotimes_{e} \right|^{C1} \mathbf{\Sigma}_{e}^{L}$ C1 L3A(11) B2 L3A(11) L3A(11) C1 L3A(11) EM _____L3A(11) L3A(11) \bigcirc D1 C1 L3A(11) THIRD FLOOR LIGHTING PLAN - MENS 1/4" = 1'-0"

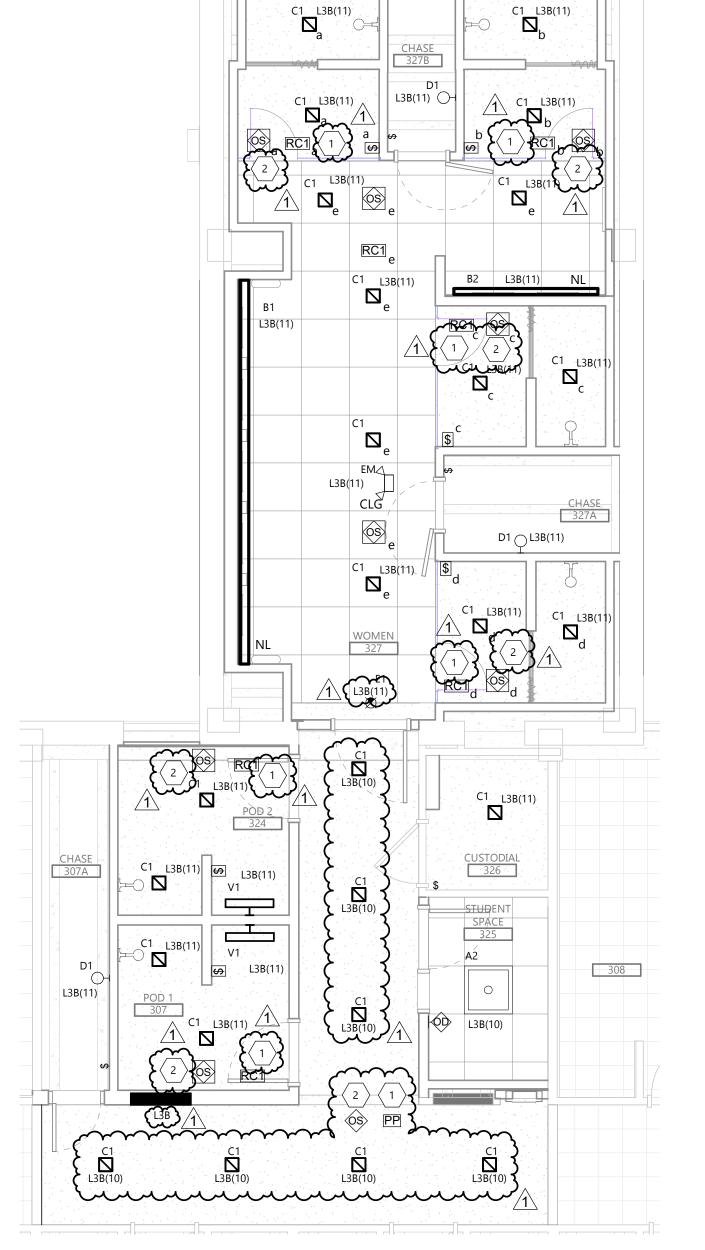



- A. RECONNECT ANY LIGHTING OR POWER CIRCUIT INADVERTENTLY DISCONNECTED BY DEMOLITION.
- B. LABEL ALL JUNCTION BOXES ABOVE ACCESSIBLE CEILING WITH INDELIBLE INK TO INDICATE PANEL AND CIRCUIT.
- C. LABEL ALL HOMERUNS WITH INDELIBLE INK TO INDICATE PANEL AND CIRCUIT.
- D. PROVIDE 4" HILTI PASS-THRU FOR CABLE PASSING THROUGH FIRE WALLS AND FLOORS.
- E. LABEL ALL DEVICES, INCLUDING SWITCHES, TO INDICATE PANEL AND CIRCUIT. USE
- AFTER DEMOLITION, EC SHALL DETERMINE THE NUMBER OF CIRCUITS AVAILABLE AND CONSULT WITH ENGINEER TO REVISE CIRCUITRY AS REQUIRED.
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- H. PROVIDE ALL DEVICES AND ASSOCIATED WIRING AS SHOWN.

KEYNOTE LEGEND:

ADHESIVE MYLAR TYPE.

< < INDICATES KEYNOTE ON PLAN
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- $\overset{\leftarrow}{\wedge}\overset{\leftarrow}{\sim}{\wedge}\overset{\leftarrow}{\wedge}\overset{\leftarrow}{\wedge}\overset{\leftarrow}{\wedge}\overset{\leftarrow}{\wedge}\overset{\leftarrow}{\wedge}\overset{\leftarrow}{\wedge}\overset{\leftarrow}{\wedge}\overset{\leftarrow}{\wedge}\overset{\leftarrow}$ POWER PACK OR ROOM CONTROLLER SHALL BE INSTALLED IN ACCESSIBLE CEILING AND LABEL WITH ROOM BEING CONTROLLED.
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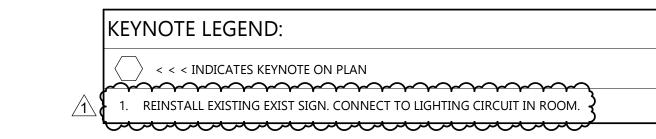
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THIRD FLOOR LIGHTING PLAN

E303

1 E303

THIRD FLOOR LIGHTING PLAN - WOMENS 1/4" = 1'-0"



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ST	ATE	SD

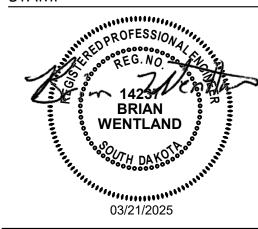
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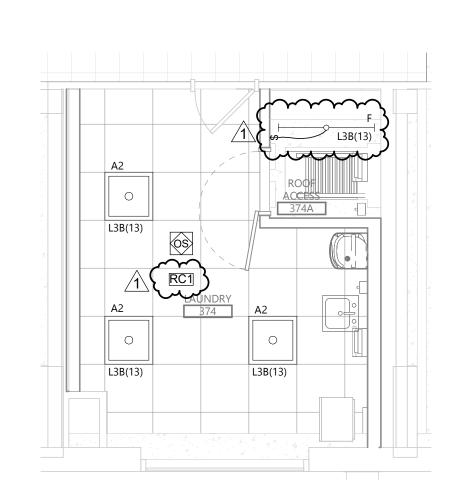
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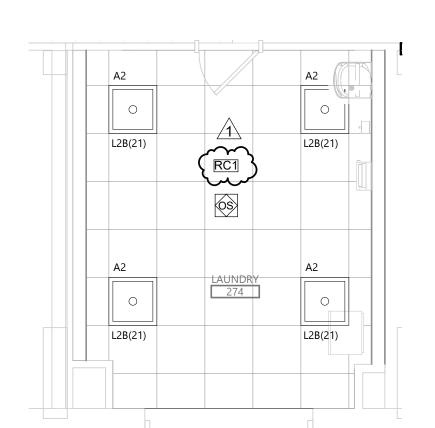
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LIGHTING PLAN - ADD


ALTERNATIVES



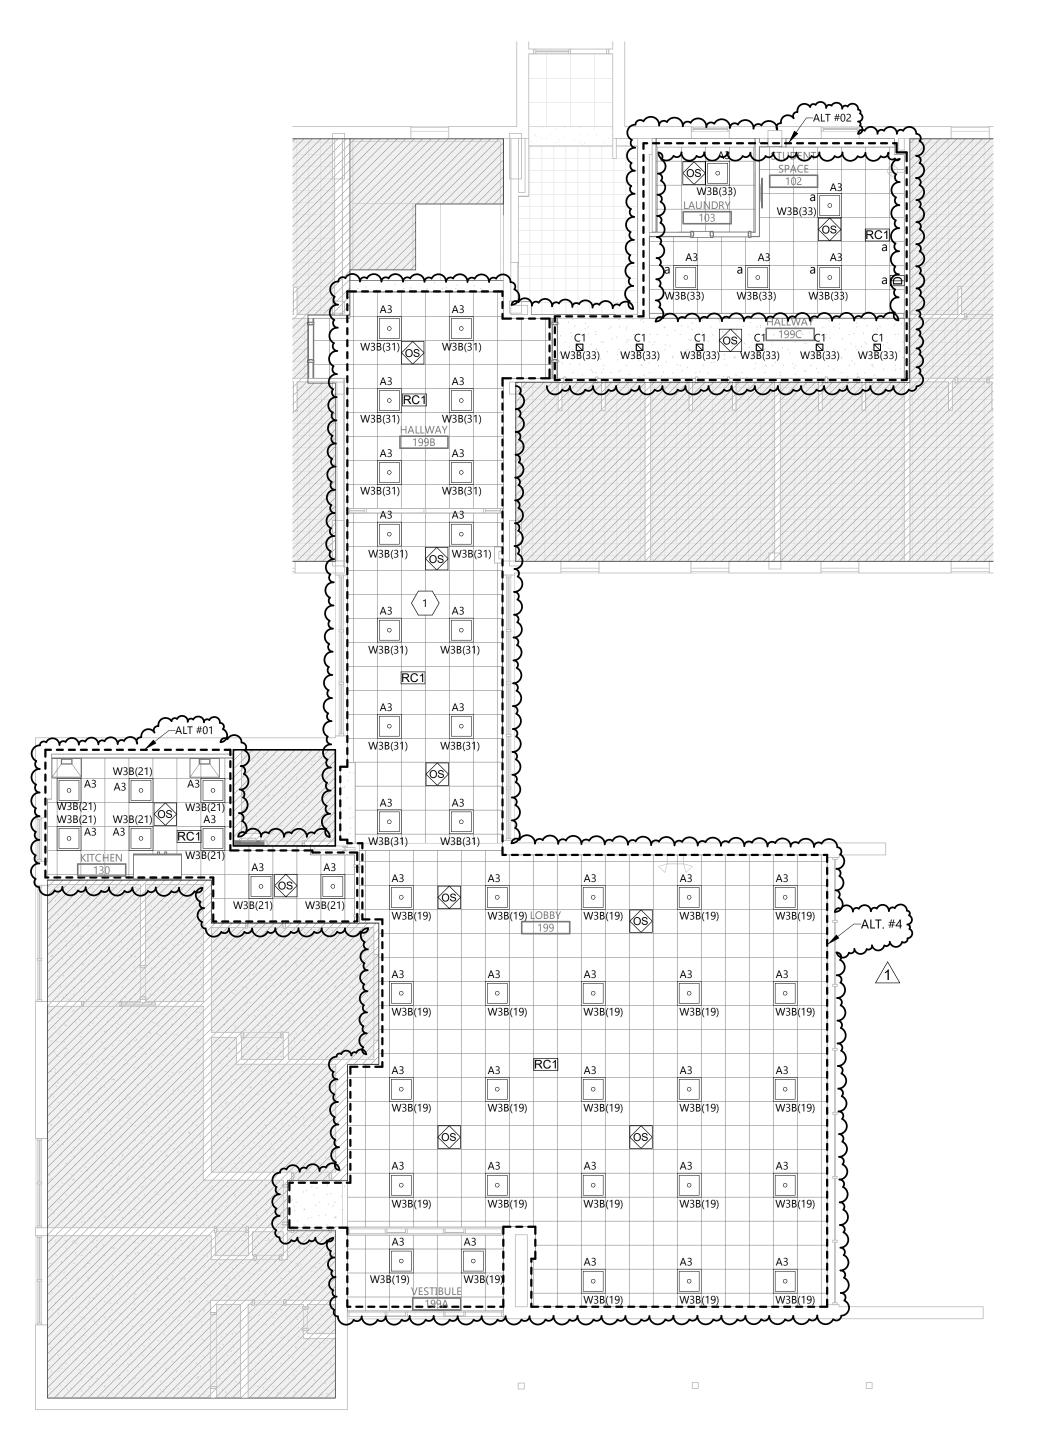3 THIRD FLOOR LAUNDRY LIGHTING PLAN (ALT #3)}








1 FIRST FLOOR LOBBY / STUDENT SPACE LIGHTING PLAN N 1/8" = 1'-0"

FEEDER SCHEDULE COPPER								
AMPACITY	FEEDER TAG	CONDUIT & THHN WIRE 75°C						
20	22	3/4" C - 2 #12 & 1 #12 GND						
30	33	3/4" C - 3 #10 & 1 #10 GND						
40	43	1" C - 3 #8 & 1 #10 GND						
100	104	1 1/2" C - 4 #2 & 1 #8 GND						

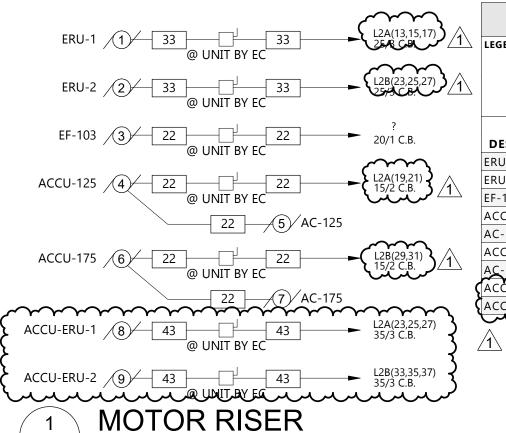

NOT TO SCALE

) <u>/1\</u>	C E	M - COMBINATI B - CIRCUIT BRE C - ELECTRICAL (X - EXISTING - FUSED	AKER	M - MAGN R MC - MECH MM - MAN	HANICAL CON		ow - o	MPERATURE OOF	CONTRACTO	OR \	RPB - REMOT SC - SELF CON /C - VENTILA WP - WEATHI	NTAINED TION CONTI	RACTOR										
				LOCATION							DII (6)		STARTER		CON	TROL	POWER	INTER	LOCKS		DISCONNEC	T	
	DESCRIPTION	N MOTOR#	FURN BY	ROOM #	HP	KW	Mean	~~~	MARY	VOLTAGE	PH (Ø)	TYPE	SIZE	ВҮ	BY	WIRING	WIRING	ВҮ	то	~~BY~~	SIZE/TYPE	NEMA~	NOTE
	ERU-1	1	МС	EXTERIOR		\ \ \ \\ \\ \\ \\ \\ \\ \\ \\ \\ \\ \\	19.35	18.01	25	208 V	3			МС			EC		(EC	30/NF/3	3R	3
\wedge	ERU-2	2	МС	EXTERIOR	~~~	\sim	19.35	18.01	25	208 V	3			МС			EC			EC	30/NF/3	3R	K
<u>/ 1 \</u>	EF-103	3	МС		FRAC.	.03				120 V	1			~~~~			مہائمہ			EC	TOGGLE		3
	ACCU-125	4	МС	EXTERIOR	Juu	my	13.5	10.6	15	208 V	1			МС			EC	}		EC	30/NF/2	3R	\supset
	AC-125	5	мс (RM 125	B/1\	ζ () 208 V	1			(MC 1			EC		(SC			3
\triangle	ACCU-175	6	МС			\	13.5	10.6	15) 208 V	1			MC 1	(EC -	{		EC	30/NF/3	3R	K
/1\	AC-175	~~~~~	MC S	RM 175	λ	~~~				208 V	1			} MC ₹			EC .	}		sc			3
	ACCU-ERU-1	8	MC	EXTERIOR	p r r	1 1 1 1 1 1 1 1 1 1 1 1 1 1 1 1 1 1 1	34.1		35	208 V	4, 4, 4,	3		мс)		EC)		EC	60/NF/3	3R	\supset
	ACCU-ERU-2	9	МС	EXTERIOR			34.1		35	208 V	3	3		МС			EC	}	(EC	60/NF/3	3R	3
3	$\dot{\gamma}$,		${}$,	, Lucy		^	VVV			5
3	<u>/1</u> \													<u>/1\</u>			1\		<u>/1\</u>	7			

MOTOR AND EQUIPMENT SCHEDULE



	Atomicoture	Linginicating
	Interior Design	Industrial
,	Interior Design TELE 605.444.1600 101 N. Phillips Ave., Ste. 300	FAX 605.444.160 1
	101 N. Phillips Ave., Ste. 300), Sioux Falls, SD 57104

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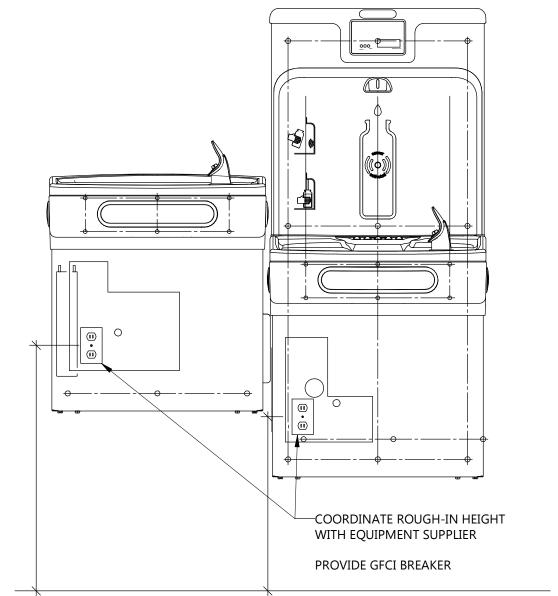
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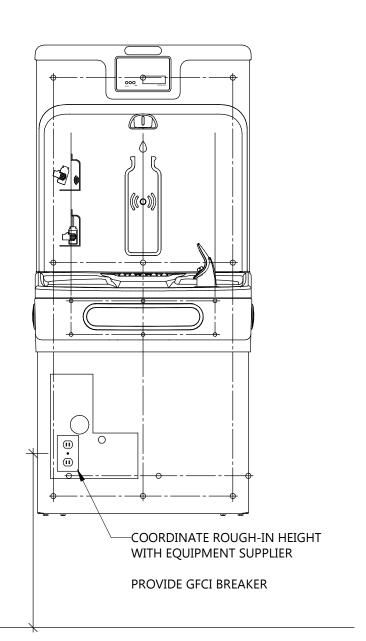
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MOTOR & EQUIPMENT SCHEDULE & RISER


E801









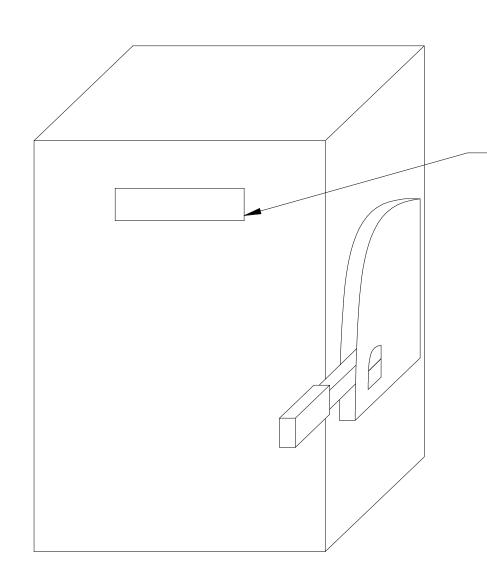

PROVIDE PLASTIC ENGRAVED NAMEPLATE WITH WHITE LETTERING AND BLACK BACKGROUND. EQUIPMENT FED FROM EMERGENCY POWER SHALL HAVE RED BACKGROUND WITH WHITE LETTERING. NAMEPLATE SHALL BE MOUNTED WITH STAINLESS STEEL HARDWARE. LABEL SHALL CONTAIN THE FOLLOWING. PROVIDE LABELS FOR ALL MCC, SWITCHBOARDS, SWITCHGEAR, PANEL BOARDS, TRANSFORMERS, DISCONNECT, VFD'S AND ELECTRICAL ENCLOSURES HOUSING PROTECTIVE BREAKERS.

> "EQUIPMENT NAME" "EQUIPMENT VOLTAGE" "EQUIPMENT AMPERAGE/POLES" "EQUIPMENT FED FROM" "FAULT CURRENT" **EXAMPLE**

DISCONNECT P-1 480V 100A/3P FED FROM HP-1 FAULT CURRENT - 6,541 A

EQUIPMENT NAMEPLATE DETAIL NOT TO SCALE

LETTED IN CIDCLE ADJACENT TO FIDE ALADM

(a) (b) (c) (c) (c) (c) (c) (c) (c) (c) (c) (c	LETTER IN CIRCLE ADJACENT TO FIRE ALARM CIRCUITRY INDICATES THE NUMBER OF FIRE ALARM CONDUCTORS REQUIRED. REFERENCE FIRE ALARM FEEDER SCHEDULE (TYPICAL)
B SD B FR	B E B
B FR D _S D _S	S M M
3 8 E D S S S S F	E E E E E E
B B FS TS IAM A 4	E E E S WP (BLDG EXTERIOR)
FIRE ALARM ANNUN. PANEL (FAAN)	FIRE ALARM CONTROL (FACP)
	2

		<u>FIRE</u>	ALAF	<u>RM FEEDER SCH</u>	<u>EDULE</u>
MADIZ	COI	NDUIT	CONDU	JCTORS PER CONDUIT	NOTES
MARK	NO.	SIZE	#14	* COMMUNICATIONS CABLE	INOTES
A	1	1/2"	-	-	2#12 AWG
B	1	1/2"	2	-	-
©	1	1/2"	4	-	-
(D)	1	1/2"	2	1	-
E	1	1/2"	-	1	-
F	1	1/2"	-	-	(1)CATEGORY 5E UTP
G	1	3/4"	5	1	-
Θ	1	-	-	-	-
(J)	1	-	-	-	-
K	1	-	-	-	-
* (()	ANALINI	ICATION	S CARLE	TO BE 1_#18GA TW/ISTED	CHIELDED DVID

		FIRE	ALAI	RM FEEDER SCH	<u>EDULE</u>	GENERAL NOTE:
MARK	COI NO.	NDUIT SIZE	CONDI #14	UCTORS PER CONDUIT * COMMUNICATIONS CABLE	NOTES	A. DETAIL SHALL BE USED FOR (MANUFACTURERS RECOMMI
A	1	1/2"	-	-	2#12 AWG	
B	1	1/2"	2	-	-	REFERENCE NOTE
©	1	1/2"	4	-	-	<u> </u>
(D)	1	1/2"	2	1	-	1 TO DEDICATED 20/1 CIRCU
E	1	1/2"	-	1	-	2 TO TELEPHONE DEMARK F
F	1	1/2"	-	-	(1)CATEGORY 5E UTP	3 TO NEXT DEVICE.
G	1	3/4"	5	1	-	SIEGERAL CONTRACTOR
\oplus	1	-	-	-	-	4 ELECTRICAL CONTRACTOR INSTALLED BY THE SPRINK
(J)	1	-	-	-	-	SPRINKLER CONTRACTOR.
K	1	-	-	-	-	5 ELECTRICAL CONTRACTOR ON BUILDING EXTERIOR BY
		ICATION N #975 O		: TO BE 1-#18GA, TWISTED, L)	SHIELDED PAIR.	EXTEND 120V POWER FRO 6 TO NEAREST CONTINUOUS

EQUIPMENT PRIOR TO INSTALLATION.

1 TO DEDICATED 20/1 CIRCUIT BREAKER.

2 TO TELEPHONE DEMARK FOR REMOTE REPORTING.

MARK	COI	NDUIT	COND	UCTORS PER CONDUIT	NOTES	A. DETAIL SHALL BE USED FOR GENE
IVIARK	NO.	SIZE	#14	* COMMUNICATIONS CABLE	NOTES	MANUFACTURERS RECOMMENDA
A	1	1/2"	-	-	2#12 AWG	
B	1	1/2"	2	-	-	REFERENCE NOTES:
©	1	1/2"	4	-	-	
(D)	1	1/2"	2	1	-	1 TO DEDICATED 20/1 CIRCUIT BE
E	1	1/2"	-	1	-	2 TO TELEPHONE DEMARK FOR R
F	1	1/2"	-	-	(1)CATEGORY 5E UTP	3 TO NEXT DEVICE.
G	1	3/4"	5	1	-	
Θ	1	-	-	-	-	4 ELECTRICAL CONTRACTOR TO A INSTALLED BY THE SPRINKLER O
(J)	1	-	-	-	-	SPRINKLER CONTRACTOR.
K	1	-	-	-	-	5 ELECTRICAL CONTRACTOR TO A ON BUILDING EXTERIOR BY SPR
* CON	MI IM	ICATION	S CARLE	TO BE 1-#18GA TWISTED	SHIFL DED PAIR	EXTEND 120V POWER FROM NE

INSTALLED BY THE SPRINKLER CONTRACTOR. VERIFY QUANTITY LOCATION AND EXACT REQUIREMENTS WITH SPRINKLER CONTRACTOR. 5 ELECTRICAL CONTRACTOR TO ALLOW IN BID TO WIRE SPRINKLER FLOW ALARM BELL FURNISHED AND INSTALLED ON BUILDING EXTERIOR BY SPRINKLER CONTRACTOR. PROVIDE LOW VOLTAGE TRANSFORMER (IF REQUIRED) AND EXTEND 120V POWER FROM NEAREST CONTINUOUS SOURCE. 6 TO NEAREST CONTINUOUS 120 VOLT SOURCE. 7 AIR HANDLING UNIT AND ASSOCIATED MOTOR CONTROLLER.

9 SMOKE DAMPERS FURNISHED AND INSTALLED BY MECHANICAL CONTRACTOR, WIRED BY ELECTRICAL CONTRACTOR. TRANSFORMER BY MC, ISOLATION SWITCH BY EC.

(8) REMOTE DUCT SMOKE DETECTOR ALARM INDICATOR AND TEST SWITCH. VERIFY EXACT LOCATION WITH MECHANICAL

A. DETAIL SHALL BE USED FOR GENERAL WIRING DESIGN INTENT ONLY. VERIFY EXACT REQUIREMENTS AND COMPLY WITH MANUFACTURERS RECOMMENDATIONS FOR ACTUAL EQUIPMENT FURNISHED.

4 ELECTRICAL CONTRACTOR TO ALLOW IN BID TO WIRE ALL TAMPER AND FLOW SWITCHES FURNISHED AND

10 TO NEXT SMOKE DAMPER. DO NOT EXCEED (6) SMOKE DAMPERS PER RELAY.

UTILITY XFMR

800A/3P

104

104

PARTIAL ONE-LINE DIAGRAM

'L3A'

100A/3P

100A/3P

/ LSIG

MDP

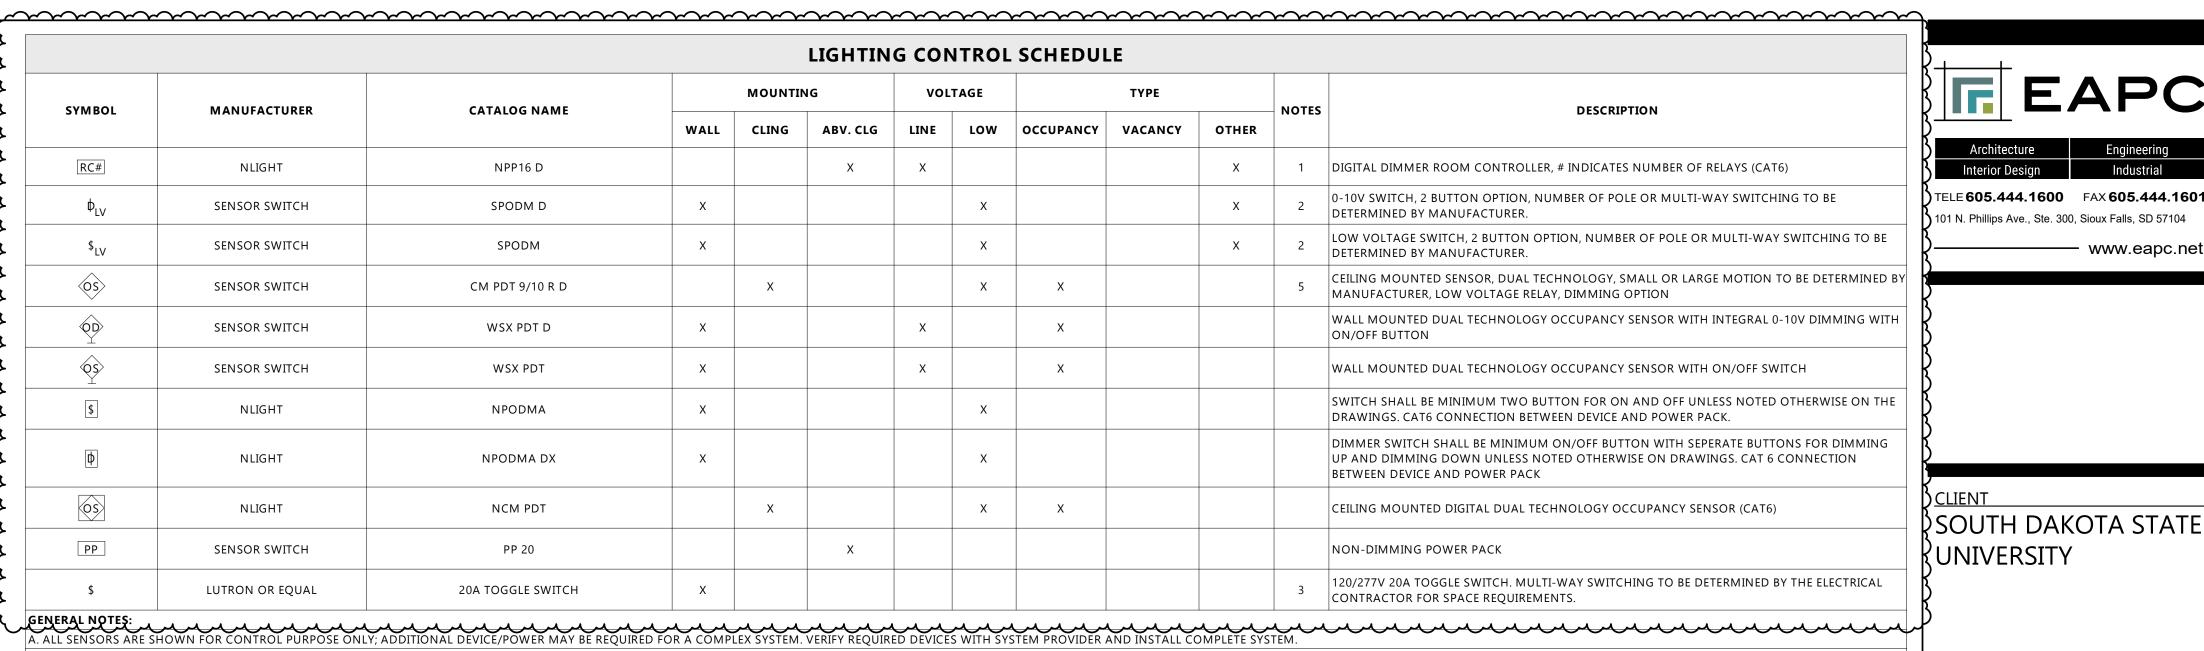
800A 120/208V 3PH 4W XXK AIC

E801

NOT TO SCALE

TYPICAL ADDRESSIBLE FIRE ALARM RISER

E801 NOT TO SCALE



B. WIRE LIGHTING CONTROL COMPONENTS PER MANUFACTURERS INSTRUCTIONS. . APPROVED MANUFACTURERS: WATTSTOPPER, CRESTRON, ACUITY BRANDS.

D. SEE SPECICICATION SECTION 262726 OR ON DRAWINGS SPECIFICATIONS FOR FACEPLATE AND DEVICE COLOR.


- 1. NUMBER REPRESENTS QUANTITY OF RELAYS PER DEVICE. SEE LIGHTING SHEETS FOR NUMBER OF RELAYS AND CONTROL ZONES. MULTI-RELAY ROOM CONTROLLERS MAY BE USED IN LIEU OF SINGLE RELAY ROOM CONTROLLERS.
- 2. SEE SWITCH DETAILS FOR MORE INFORMATION ON SPECIFIC TIMECLOCK SWITCHES/DIMMERS BUTTON LAYOUT AND ENGRAVING.
- 3. FOR USE AT BACK OF HOUSE, UNFINISHED SPACES, AND 120V 20A MOTOR DISCONNECTS SHALL BE STANDARD TOGGLE SWITCHES. SEE SPECIFICATION SECTION 262726 OR ON DRAWINGS SPECICICATION FOR ADDITIONAL INFORMATION.
- 4. A LINE VOLTAGE DIMMER SHALL ONLY BE USED IN RESIDENTAL INSTALLATIONS OR WHERE THE LUMINAIRE SUPPORTS ONLY LINE VOLTAGE DIMMING.
- 5. MANUFACTURER SHALL DETERMINE IF SENSOR SHALL COME WITH INTEGRAL PHOTOCELL IN LIEU OF STAND ALONG DEVICE AS NEEDED FOR DEVICE.

				LUMINAIRE	SCHEDULE						
ГҮРЕ	MANUFACTURER	CATALOG NUMBER	LAMP	MOUNTING	LOCATION	VOLTAGE	ССТ	LUMENS	WATTS	NOTES	DESCRIPTION
A2	LITHONIA	CPX-2X2-3200LM-80CRI-40K-SWL-MIN1-ZT-MVOLT	LED	RECESSED	CEILING	MVOLT	4000	3200	30	}	2X2 LED
43	LITHONIA	CPX-2X2-2000LM-80CRI-40K-SWL-MIN1-ZT-MVOLT	LED	RECESSED (CEILING	MVOLT	4000	2000	16	}	2X2 LED
31	FOCAL POINT	FSM2L-FL-250LF-40K-UNV-LD1-G1-16'	LED	RECESSED	CEILING	MVOLT	4000	250LM/FT	3W/FT	}	16' LINEAR LED
32	FOCAL POINT	FSM2L-FL-250LF-40K-UNV-LD1-G1-6'	LED	RECESSED (CEILING	MVOLT	4000	250LM/FT	3W/FT	}	6' LINEAR LED
1	SATCO	S11831	LED	RECESSED	CEILING	120	4000	1750	3 24		CANLESS 8" SQUARE LED DOWNLIGHT
01	LITHONIA	TWR1-LED-SWW2-UVOLT-PE-DDBTXD	LED	WALL (WALL	MVOLT	4000	2300	16		SURFACE MOUNT LED
E 1	LITHONIA	LQM-S-W-3-R-120/277-M6	LED	SURFACE	CEILING	120			5	}	EXIT SIGN W/ 90-MIN BATTERY BACKUP
M	LITHONIA	ELM2L FLM2L	LED	SURFACE (CEILING	120			5	Z	SURFACE MOUNT EMERGENCY FIXTURE W/ 90-MIN BATTERY
<u>-</u>	LITHONIA	ZL 1D	LED	SUSPENDED	CEILING	120	4000	4000	30		CHAIN SUSPENDED STRIP LIGHT WITH ROUND DIFFUSED LEN

BUILDING STRUCTURE —MAXIMUM 6'-0" FLEX ___LUMINAIRE SUPPORT WHIP LENGTH WIRES AT EACH CORNER OF EACH TROFFER BY DIVISION —CEILING GRID. TROFFER BY DIVISION 26.

> 1. DO NOT LOOP FLEX WHIPS FIXTURE-TO- FIXTURE. PROVIDE JUNCTION BOX AS SHOWN. 2. FLEX WHIP SHALL NOT REST ON CEILING GRID. PROVIDE ADDITIONAL SUPPORTS AS NEEDED.

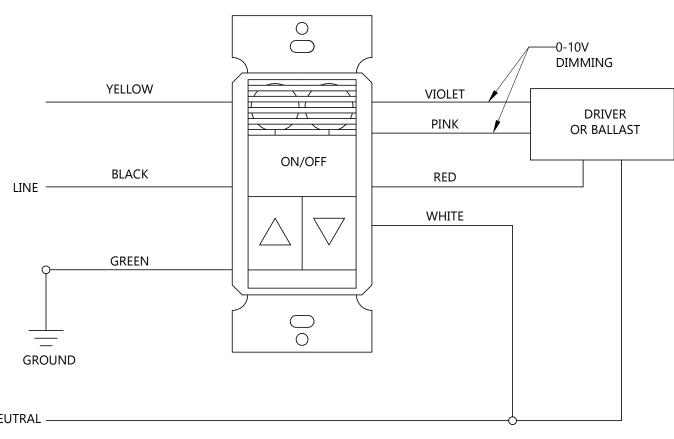TROFFER INSTALLATION DETAIL E802 NOT TO SCALE



NOTE: REQUIRES CLASS 1 WIRING FOR 0-10V DIMMING

NOT TO SCALE

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CD 100% CONSTRUCTION 03/13/2025

Architecture

PROJECT DESCRIPTION

HALL RENOVATE

R0325--15X)

STATE

ISSUE DATES

1 ADDENDUM 1

DOCUMENTS

MARK DESCRIPTION

RESTROOM (OSE#

SWN 0509, WANETA

TELE 605.444.1600 FAX 605.444.1601

www.eapc.net

BROOKINGS

101 N. Phillips Ave., Ste. 300, Sioux Falls, SD 57104

03/21/2025 DRAWING TITLE

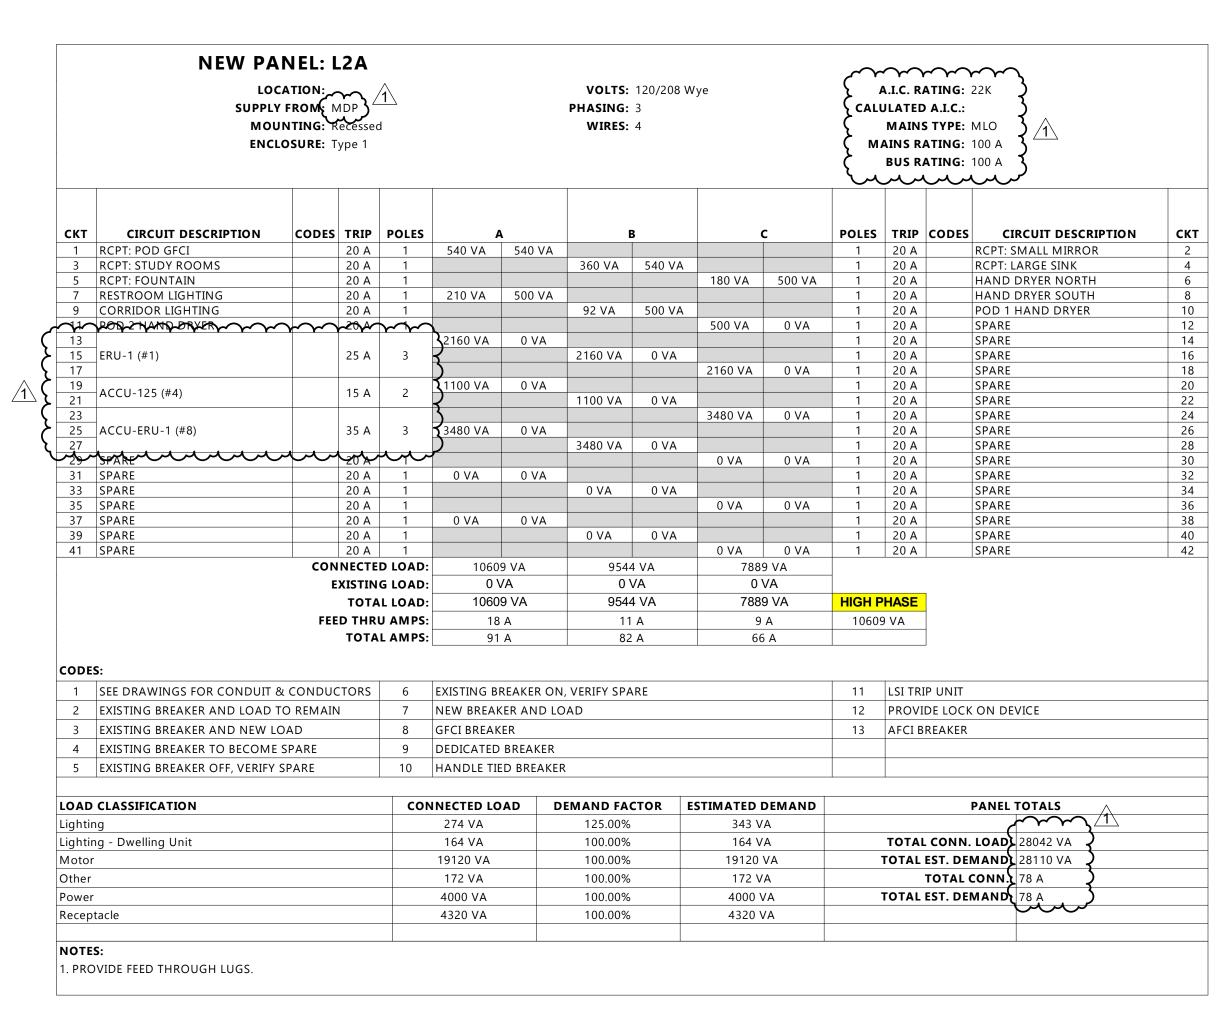
BRIAN **WENTLAND**

LIGHTING SCHEDULES & DETAILS

E802


E802

DUAL TECH SENSOR SWITCH OD WIRING DETAIL



	SUPPLY MOU	ATION FROM: N FROM: N UNTING: R OSURE: T	MDP Kecessed	1			VOLTS: PHASING: WIRES:	_	Wye		CALL MA	A.I.C. RA JLATED MAINS AINS RA BUS RA	ATING: A.I.C.: TYPE: ATING: ATING:	22 K MLO 100 A 100 A	
скт	CIRCUIT DESCRIPTION	CODES	TDID	POLES	<u> </u>		В		c		POLES	TDID	CODES	CIRCUIT DESCRIPTION	СКТ
1	RCPT: PODS GFCI	CODES	20 A	1	540 VA	540 VA	В				1	20 A	CODES	RCPT: LARGE SINK GFCI	2
3	RCPT: JANITOR		20 A	1	340 VA	340 VA	180 VA	540 VA			1	20 A		SHORT SINK GFCI	4
5	RCPT: FOUNTAIN		20 A	1					180 VA	500 VA	1	20 A		RESTROOM HAND DRYER A	6
7	RCPT: STUDY		20 A	1	180 VA	500 VA					1	20 A		RESTROOM HAND DRYER B	8
9	RESTROOM LIGHTING		20 A	1			46 VA	210 VA		$\sim \sim$	$\sim \sim \sim$	28A	$\sim\sim$	CORRIDOR WETHING	A-10-
11	WASHER A	2-0-0	20 A	1	-00004		$\sim\sim$	\sim		1500 VA	2	30 A	8	DRYER A	12
15	YM7ASHIER/SYYYYYY	<u> </u>	~28×		~\\\\\\\\\\\\\\\\\\\\\\\\\\\\\\\\\\\\\	1500 VA	1500 VA		\$\$\$\$\$			20/4		hept: counter a pountain	14
17	DRYER B	8	30 A	2			1300 171	,	1500 VA	180 VA	1	20 A		RCPT: APPLIANCE	18
ىروادر	POD LHAND DRYER	m	مع ہے۔	$\mathcal{M}_{\mathbf{M}}$	~500VA	-AU003-	m	mu	~ ~ ~ <i>}</i>	4	\sim	A DIE	\sim	POUD 2 HAND DRYER ***	~~29~
•	TICHTING TATHADEA	\sim	~20,4~	$\boldsymbol{\sim}\boldsymbol{\sim}$	\		184 VA	0 VA	216214	}	2	30 A	8	RCPT: RM 103 DRYER	22
23 25			25.4	3	2160 VA	180 VA			2160 VA	0 VA }	1			RCPT: RM 103	24 26
27	_ ERU-2 (#2)		25 A	3	\$2160 VA	160 VA	2160 VA	0 VA		\	<u>,,,,,,,,,,,,,,,,,,,,,,,,,,,,,,,,,,,,,</u>	20 A	<i>~</i> ~	SPARE SPARE	~ 2°
29	1.001.177 (#6)		4= 4		{		2100 VA	O VA	0 VA	0 VA	1	20 A		SPARE	30
31	ACCU-175 (#6)		15 A	2) 0 VA	0 VA					1	20 A		SPARE	32
33					5		3480 VA	0 VA			1	20 A		SPARE	34
35	ACCU-ERU-2 (#9)		35 A	3	3,400,1/4	0.1/4			3480 VA	0 VA	1	20 A		SPARE	36
37 	CPART OF THE PART		20 A	~~~) 3480 VA	0 VA	0 VA	0 VA			1 1	20 A 20 A		SPARE SPARE	38 40
	SPARE		20 A	1			OVA	O VA	0 VA	0 VA	1	20 A		SPARE	42
		CON	NECTE	D LOAD:	1306	1 VA	9925	S VA	10929	VA		•			•
		E	XISTIN	G LOAD:	0 \	/A	0 V	/A	0 V	Ά					
			TOTA	L LOAD:	1306	1 VA	9925	5 VA	10929	VA	HIGH P	HASE			
		FEE	D THR	J AMPS:	23	Α	11	Α	10	A	13061	VA			
			TOTA	L AMPS:	110) A	83	Α	92	A					
CODE	S:														
1	SEE DRAWINGS FOR CONDUIT 8	& CONDUC	CTORS	6	EXISTING BI	REAKER ON	I, VERIFY SPA	RE			11	LSI TRI	P UNIT		
2	EXISTING BREAKER AND LOAD T	TO REMAIN	١	7	NEW BREAK	(ER AND LO	DAD				12	PROVI	DE LOCK	ON DEVICE	
3	EXISTING BREAKER AND NEW LO	OAD		8	GFCI BREAK	ER					13	AFCI B	REAKER		
4	EXISTING BREAKER TO BECOME	SPARE		9	DEDICATED	BREAKER									
5	EXISTING BREAKER OFF, VERIFY	SPARE		10	HANDLE TIE	D BREAKE	R								
LOAD	CLASSIFICATION			CON	INECTED LO	AD D	EMAND FAC	TOR	ESTIMATED D	FM A N D				PANEL TOTALS	
Lightin					547 VA		125.00%		684 VA					ANTE TOTALS	
	ng - Dwelling Unit				164 VA		100.00%		164 VA			ΤΟΤΔΙ	CONN	. LOAD: 33915 VA	
Motor	<u> </u>				16920 VA		100.00%		16920 V					MAND: 34052 VA	
Other					172 VA		100.00%		172 VA					CONN.: 94 A	
Power					10000 VA		100.00%		10000 V		-			MANQ: 95 A	
Recep					6120 VA		100.00%		6120 V			· UIAL	-51. DE	MANU. 93 A	
	~~~~~~~~~~~~~~~~~~~~~~~~~~~~~~~~~~~~~~						, 5 5 . 5 6 7 6		5120 V/					<u> </u>	

	SUPPLY MOU	ATION: FROM: L NTING: R OSURE: T	2A \\ ecessed	1			VOLTS: PHASING: WIRES:		Wye		CALU	JLATED MAINS AINS RA BUS RA	ATING: 22 K D A.I.C.: S TYPE: MLO ATING: 100 A ATING: 100 A	
скт	CIRCUIT DESCRIPTION	CODES	TRIP	POLES		A	I	В		c	POLES	TRIP	CODES CIRCUIT DESCRIPTION	CK
1	RCPT: PODS GFCI		20 A	1	540 VA	500 VA					1	20 A	POD 1 HAND DRYER	2
3	RCPT: FOUNTAIN		20 A	1			180 VA	500 VA	260.144	500.1/4	1	20 A	HAND DRYER SOUTH	4
5 7	RCPT: STUDY		20 A	1	F00.1/A	F 40 \/A			360 VA	500 VA	1	20 A	RCPT: HAND DRYER NORTH	6
9	POD 2 HAND DRYER RESTROOM LIGHTING		20 A 20 A	1	500 VA	540 VA	92 VA	540 VA			1	20 A 20 A	RCPT: LARGE SINK GFCI RCPT: SHORT SINK GFCI	8 10
11	CORRIDOR LIGHTING		20 A	1			92 VA	340 VA	210 VA	0 VA	1	20 A	SPARE	12
13	SPARE		20 A	1	0 VA	0 VA			210 VA	V VA	1	20 A	SPARE	14
15	SPARE		20 A	1			0 VA	0 VA			1	20 A	SPARE	16
17	SPARE		20 A	1					0 VA	0 VA	1	20 A	SPARE	18
19	SPARE		20 A	1	0 VA	0 VA					1	20 A	SPARE	20
21	SPARE		20 A	1			0 VA	0 VA			1	20 A	SPARE	22
23	SPARE		20 A	1	0.1/4	0.1/4			0 VA	0 VA	1	20 A	SPARE	24
25 27	SPARE SPARE		20 A 20 A	1	0 VA	0 VA	0 VA	0 VA			1 1	20 A 20 A	SPARE SPARE	26
29	SPARE		20 A	1			UVA	UVA	0 VA	0 VA	1	20 A	SPARE	30
31	SPARE		20 A	1	0 VA	0 VA			- UN	0 771	1	20 A	SPARE	32
33	SPARE		20 A	1	¥ 111		0 VA	0 VA			1	20 A	SPARE	34
35	SPARE		20 A	1					0 VA	0 VA	1	20 A	SPARE	36
37	SPARE		20 A	1	0 VA	0 VA					1	20 A	SPARE	38
39	SPARE		20 A	1			0 VA	0 VA			1	20 A	SPARE	40
41	SPARE	601	20 A	1	200	0.14	424	2.14	0 VA	0 VA	1	20 A	SPARE	42
				D LOAD: G LOAD:		0 VA <b>VA</b>		2 VA V <b>A</b>		9 VA <b>VA</b>				
		Е.				0 VA		2 VA		9 VA	HIGH P	LIACE	1	
				L LOAD:										
		FEE		J AMPS:		A		Α	_	Α	2080	VA	_	
			IOIA	L AMPS:	18	3 A	I	l A	9	Α				
ODE	S:													
1	SEE DRAWINGS FOR CONDUIT 8	ι CONDUC	TORS	6	EXISTING B	REAKER O	N, VERIFY SPA	ARE			11	LSI TRI	IP UNIT	
2	EXISTING BREAKER AND LOAD T			7	NEW BREA						12	PROVI	DE LOCK ON DEVICE	
3	EXISTING BREAKER AND NEW LO				GFCI BREAI								REAKER	
	EXISTING BREAKER TO BECOME				DEDICATED						13	/ \(\ CI D	THE THE T	
4				_							+			
5	EXISTING BREAKER OFF, VERIFY S	10	HANDLE TI	ED BKEAK	-K									
OAD	CLASSIFICATION			CON	INECTED LO	DAD	DEMAND FA	CTOR	ESTIMATED	DEMAND			PANEL TOTALS	
Lighting					137 VA		125.00%		171 V					
Lighting - Dwelling Unit					82 VA		100.00%		82 V.			TOTAL	L CONN. LOAD: 4461 VA	
Other					86 VA		100.00%		86 V				<b>EST. DEMAND:</b> 4495 VA	
					2000 VA		100.00%		2000 \				TOTAL CONN.: 12 A	
Power Receptacle										-		EST. DEMAND: 12 A		
есер	lacie				2160 VA		100.00%	)	2160 \	v A		IUIAL	EST. DEIVIAND: 12 A	

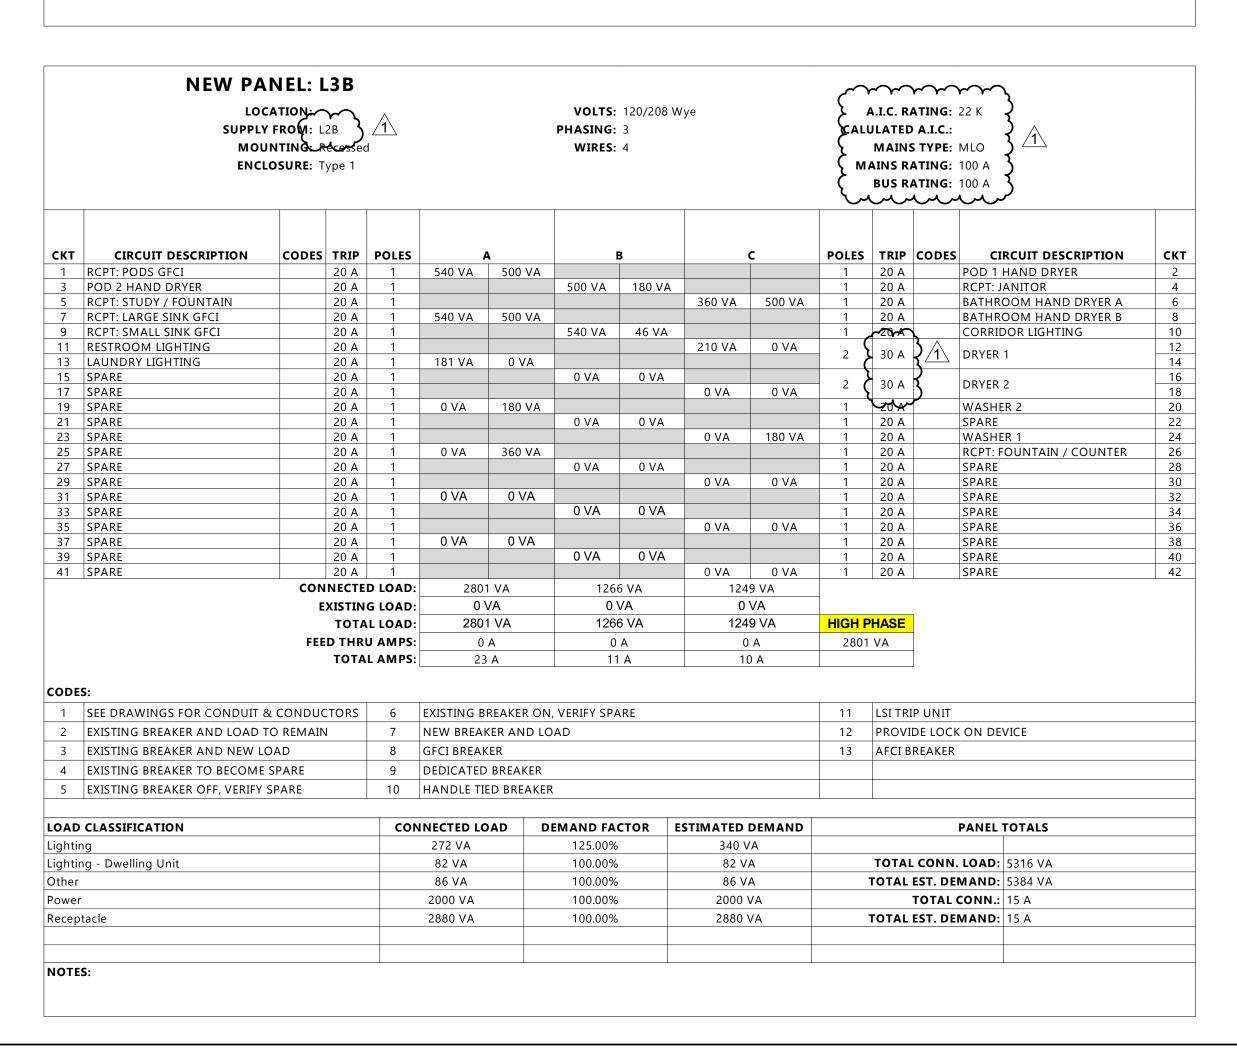



Interior Design Industrial

TELE **605.444.1600** FAX **605.444.1601**101 N. Phillips Ave., Ste. 300, Sioux Falls, SD 57104

www.eapc.net

SOUTH DAKOTA STATE UNIVERSITY

PROJECT DESCRIPTION

SWN 0509, WANETA

HALL RENOVATE

RESTROOM (OSE#

R0325--15X)

CITYBROOKINGSSTATESD


**ISSUE DATES** 

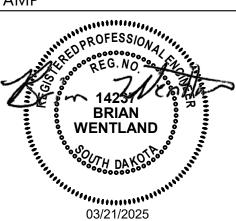1	ADDENDUM 1	03/21/2025
	100% CONSTRUCTION DOCUMENTS	03/13/2025
MARK	DESCRIPTION	DATE

PROJECT NO:	20246780
DRAWN BY:	PM
CHECKED BY:	BW

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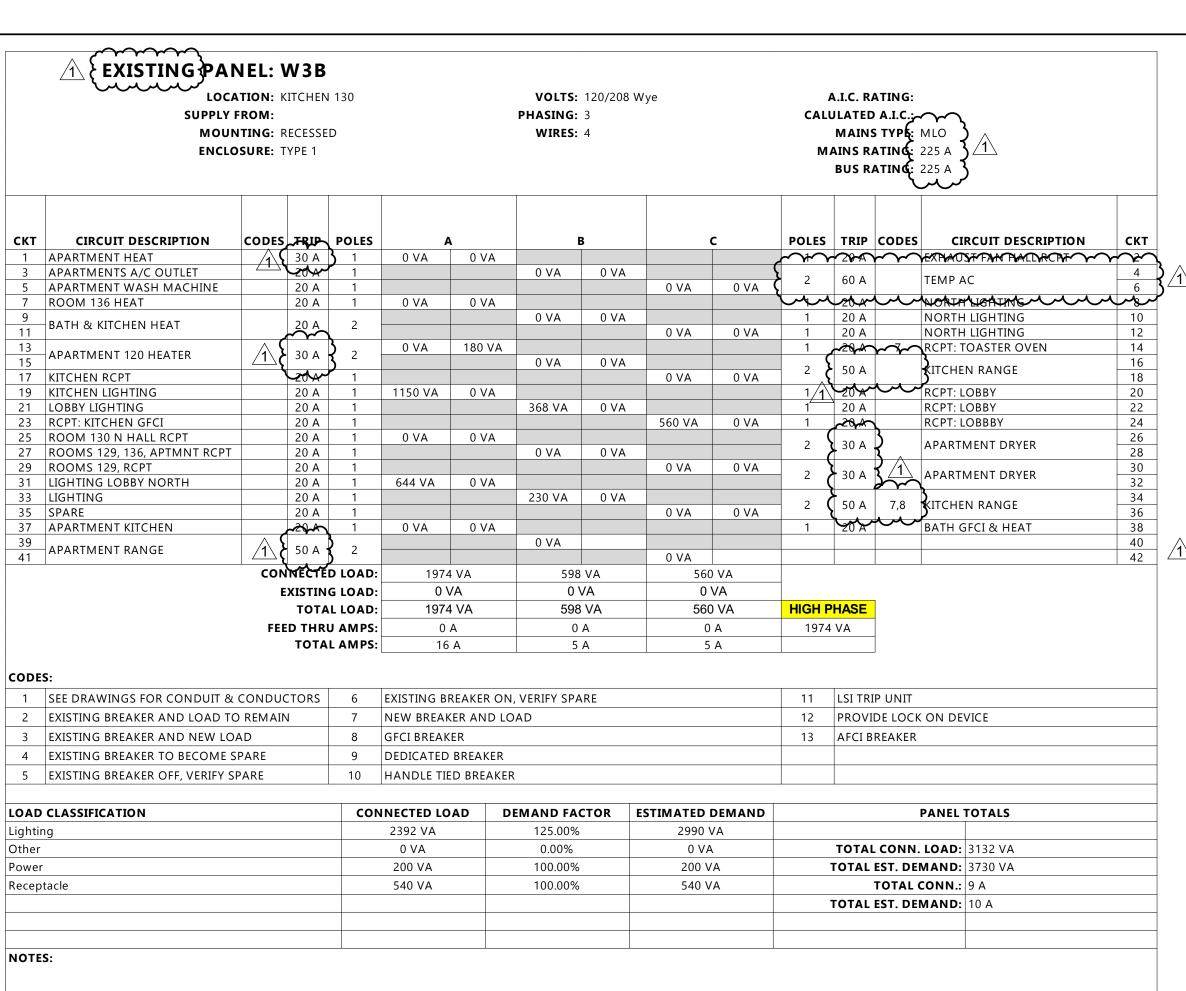
STAMP



DRAWING TITLE
SCHEDULES

E901

munum 1



	SUPPLY MOU	ATION: EX FROM: NTING: Su OSURE: Ty	urface	A 125			VOLTS: PHASING: WIRES:		Wye		A.I.C. RATING: CALULATED A.I.C.: MAINS TYPE MLO MAINS RATING: 225 A BUS RATING: 225 A						
СКТ	CIRCUIT DESCRIPTION	CODES	TRIP	POLES		Δ.		3		c	POLES	TRIP CODES	CIRCUIT DESCRIPTION	СКТ			
	EXISTING	CODES	20 A	1	0 VA	0 VA				_	1		XISTING	2			
	EXISTING		20 A	1	0 171	0 771	0 VA	0 VA			1		XISTING	4			
	EXISTING		20 A	1					0 VA	0 VA	1		XISTING	6			
7	EXISTING		20 A	1	0 VA	0 VA					1	20 A E	XISTING	8			
9	EXISTING		20 A	1			0 VA	0 VA			1	20 A E	xisting	10			
	EXISTING		20 A	1					0 VA	0 VA	1		XISTING	12			
13	EXISTING		20 A	1	0 VA	0 VA					1		XISTING	14			
15	EXISTING		20 A	1			0 VA	0 VA			1		XISTING	16			
	EXISTING		20 A	1	6.14:	0.17:			0 VA	0 VA	1		XISTING	18			
	EXISTING		20 A	1	0 VA	0 VA	0.1/4	0.1/4			1		XISTING	20			
	EXISTING		20 A	1			0 VA	0 VA	0.1/4	0.1/4	1		XISTING	22			
23	EXISTING		20 A 20 A	1	0.1/4	0 VA			0 VA	0 VA	1		XISTING XISTING	24			
25 27	EXISTING EXISTING		20 A	1	0 VA	UVA	0 VA	0 VA			1		XISTING	26 28			
	RCPT: SHORT SINK GFCI		20 A	1			UVA	UVA	360 VA		1		XISTING	30			
	RCPT: LONG SINK GFCI		20 A	1	540 VA	0 VA			300 VA		1		XISTING	32			
	RESTROOM HAND DRYER A		20 A	1	310 171	0 171	500 VA	0 VA			1		XISTING	34			
	RESTROOM HAND DRYER B		20 A	1			300 171	0 171	500 VA	0 VA	1		ORRIDOR LIGHTING	36			
	POD ADA HAND DRYER		20 A	1	500 VA	210 VA			300 171		1		ESTROOM LIGHTING	38			
	RCPT: PODS		20 A	1			540 VA	500 VA			1		OD 1 HAND DRYER	40			
41	RCPT: FOUNTAIN		20 A	1					180 VA	180 VA	1	20 A R	CPT: EXTERIOR	42			
		CONI	NECTE	D LOAD:	124	9 VA	1540	O VA	1220	0 VA							
		EX	XISTIN	G LOAD:	0 '	VA	0 \	VΑ	0 '	VA							
				L LOAD:		9 VA		) VA	122	0 VA	HIGH P	HASE					
		CCC1		U AMPS:		A	0			A	1540						
				L AMPS:		) A	13			) A	1340	VA					
CODES	3:			L AWIPS.	10	) A	13	A	10	) A							
1	SEE DRAWINGS FOR CONDUIT &	CONDUC	TORS	6	EXISTING B	REAKER ON	, VERIFY SPA	RE			11	LSI TRIP UNIT					
2	EXISTING BREAKER AND LOAD T	O REMAIN		7	NEW BREAI	KER AND LC	)AD				12	PROVIDE LOCK O	ON DEVICE				
	EXISTING BREAKER AND NEW LO			8	GFCI BREAK						13	AFCI BREAKER					
4	EXISTING BREAKER TO BECOME			9	DEDICATED						13	, i CI DILLAKLIK					
5	EXISTING BREAKER OFF, VERIFY S	SPARE		10	HANDLE TI	ED BREAKEF	₹										
	CLASSIFICATION			CON	NNECTED LO	DAD D	EMAND FA	CTOR	ESTIMATED I	DEMAND		PA	ANEL TOTALS				
LOAD	CLASSIFICATION								F.C. V	^							
					45 VA		125.00%		56 V	4							
Lightin	g											TOTAL CONN I	OAD: 4009 VA				
Lightin Lightin					82 VA		100.00%		82 V	4		TOTAL CONN. L					
Lightin Lightin Other	g g - Dwelling Unit				82 VA 86 VA		100.00% 100.00%		82 V/ 86 V/	A A		TOTAL EST. DEM	<b>AND:</b> 4020 VA				
Lightin Lightin	g - Dwelling Unit				82 VA		100.00%		82 V	A A /A	•	TOTAL EST. DEM	AND: 4020 VA DNN.: 11 A				

		REVISED PANI	EL: W4 <i>A</i>	4											
		SUPPLY FROM MOUNTS	ION: EX. DAT OM: ING: SURFAC URE: TYPE 1				VOLTS PHASING WIRES		Wye		CAL	A.I.C. RATIN ULATED A.I MAINS TY IAINS RATIN BUS RATIN	.C.: PE: MLO 1 NG: 223 A		Architecture Engineer Interior Design Industr
															TELE <b>605.444.1600</b> FAX <b>605.4</b> 4
	CVT	CIDCUIT DESCRIPTION	CODEC TRID	DOLES		•		В		•	DOLEC	TRIP CO	DEC. CIRCUIT DESCRIPTION	CKT	101 N. Phillips Ave., Ste. 300, Sioux Falls, SD
_	<b>CKT</b> 1	CIRCUIT DESCRIPTION C EXISTING	CODES TRIP		0 VA	<b>A</b> 0 VA		В		_	POLES	TRIP CO	DES CIRCUIT DESCRIPTION  EXISTING	<b>CKT</b> 2	
		EXISTING	20 A		UVA	UVA	0 VA	0 VA			1	20 A	EXISTING	4	www.ea
	5	EXISTING	20 A				0 1/1	0 1/1	0 VA	0 VA	1	20 A	EXISTING	6	
	7	EXISTING	20 A		0 VA	0 VA			5 171	J 771	1	20 A	EXISTING	8	
_	9	EXISTING	20 A	_		1	0 VA	0 VA			1	20 A	EXISTING	10	
_		EXISTING	20 A				J	1 3	0 VA	0 VA	1	20 A	EXISTING	12	
-		EXISTING	20 A	_	0 VA	0 VA					1	20 A	EXISTING	14	
-		EXISTING	20 A				0 VA	0 VA			1	20 A	EXISTING	16	
_		EXISTING	20 A						0 VA	0 VA	1	20 A	EXISTING	18	
		EXISTING	20 A		0 VA	0 VA					1	20 A	EXISTING	20	
	21	EXISTING	20 A	. 1			0 VA	0 VA			1	20 A	EXISTING	22	
	23	EXISTING	20 A	. 1					0 VA	0 VA	1	20 A	EXISTING	24	
	25	EXISTING	20 A	. 1	0 VA	540 V	A				1	20 A	RCPT: CORRIDOR	26	
	27	EXISTING	20 A	. 1			0 VA	540 VA			1	20 A	RCPT: LARGE SINK GFCI	28	
	29	EXISTING	20 A	. 1					0 VA	540 VA	1	20 A	RCPT: SMALL SINK GFCI	30	
	31	RESTROOM LIGHTING	20 A	. 1	210 VA	500 V	Α				1	20 A	NORTH HAND DRYER	32	
	33	CORRIDOR LIGHTING	20 A	. 1			0 VA	500 VA			1	20 A	SOUTH HAND DRYER	34	
_		POD ADA HAND DRYER	20 A						500 VA	180 VA	1	20 A	RCPT: FOUNTAIN	36	CLIENT
		WASHER THE STATE OF THE STATE O	AGE A	$\gamma \gamma \gamma \gamma$	1480HAY						1	20 A	RCPT: EXTERIOR	38	
	39	DRYER	8 30 A	. 2			1500 VA	272044	$\sim\sim$		1	20 A	RCPT: STUDENT SPACE	40	South Dakota St
	41								1500 VA	500 VA	1	20 A	POD 1 HAND DRYER	42	LINITY/EDCITY/
<u> </u>			~ COUNTECT	<b>ዸ</b> ፝ኯጚ፞፞፞፞፞፞፞ዾኯ			~~~ <u>~</u>		بريوست	VA					UNIVERSITY
			EXISTII	NG LOAD	: 0	VA	0	VA	0 '	<b>V</b> A					
			тот	AL LOAD	: 142	29 VA	326	60 VA	3220	) VA	HIGH I	PHASE			
				RU AMPS		) A		) A	0			0 VA			
				AL AMPS		2 A		9 A	29		320	0 171			
			101	AIVIF 3	•!	<u>-                                    </u>	1 2	<u> </u>		- 17	1				
C	ODE	S:													PROJECT DESCRIPTION
	1	SEE DRAWINGS FOR CONDUIT & CO	ONDUCTORS	6	EXISTING I	BREAKER (	ON, VERIFY SP	ARE			11	LSI TRIP UI	NIT		CVAVALOFOO VAVAALET
	2	EXISTING BREAKER AND LOAD TO R	REMAIN	7	NEW BREA	KER AND	LOAD				12	PROVIDE L	OCK ON DEVICE		SWN 0509, WANET
	3	EXISTING BREAKER AND NEW LOAD	)	8	GFCI BREA	KER					13	AFCI BREA	KER		HALL RENOVATE
	4	EXISTING BREAKER TO BECOME SPA	ARE	9	DEDICATE	D BREAKE	R								
	5	EXISTING BREAKER OFF, VERIFY SPA	.RE	10	HANDLE T	IED BREAK	KER								RESTROOM (OSE#
				<u> </u>											R032515X)
L	OAD	CLASSIFICATION		СО	NNECTED L	OAD	DEMAND FA	CTOR	ESTIMATED I	DEMAND			PANEL TOTALS		
Li	ghtir	ng			45 VA		125.00%	%	56 V	4					
Li	ghtir	ng - Dwelling Unit			82 VA		100.00%	%	82 V	4		TOTAL CO	NN. LOAD: 7909 VA		CITY BROOK

100.00%

100.00%

100.00%

86 VA

5000 VA

2700 VA

TOTAL EST. DEMAND: 7920 VA

TOTAL EST. DEMAND: 22 A

TOTAL CONN.: 22 A

86 VA

5000 VA

2700 VA

Receptacle

NOTES:

CITY	BROOKINGS
STATE	SD


**ISSUE DATES** 

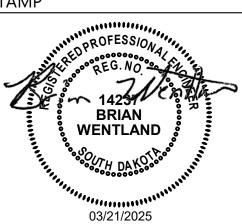1	ADDENDUM 1	03/21/2025
CD	100% CONSTRUCTION DOCUMENTS	03/13/2025
MARK	DESCRIPTION	DATE

PROJECT NO:	20246780
DRAWN BY:	PM
CHECKED BY:	BW
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NOTES: